



Artist Impression 1 - Aerial view looking south across Parramatta River to Rhodes & Olympic Park beyond.

JULY 2012 | REV 2



Rothesay Avenue:



Belmore Street:



ROBERTSON+MARKS ARCHITECTS | 2 PLACE DESIGN GROUP



CONCEPT PLAN: TITLE	No.		RESPONSE	ITEM OR ANNEXURE REFERENCE
Area	1.	(Dept of Planning letter dated 22/03/12) A table indicating the area (in hectares or m2) of each property within the Concept Plan and the total site area.	Details of areas of individual lots within the Concept Plan site is provided.	1
Floor space	2.	Floor space calculations for each building envelope (across each level) should be provided including diagrams where appropriate.	Floor space calculations for each building envelope across the Concept Plan site is provided and included in separate plans.	2
	3.	Confirmation if the commercial floor space will be solely located within the 'signature building' (as referred to on page 56) and/or adjacent to the central foreshore plaza open space (page 28)	As stated in the PPR, there is now limited market for additional commercial space within the Meadowbank area. In addition to the dedicated commercial space provided in the 'Gateway building' on Church Street, the Concept Plan provides for flexibility for possible use of ground floor as commercial or residential spaces across all stages with higher, 3.6m floor to floor heights to enable proposed building use to be adapted, dependent on market demands into the future. In addition, the Concept Plan envisages permitting mobile kiosks in publicly accessible open spaces across the Concept Plan site with locations determined in consultation with Council.	
Sections and Perspectives	4.	Long Sections of the proposed envelopes from Bowden Street to Belmore Street (at the Foreshore, Constitution Road frontage and Nancarrow Avenue frontage) and from Constitution Road down to the foreshore. The long sections should include existing development adjacent to the site.	Long Sections of the proposed envelopes from Bowden Street to Belmore Street (at the Foreshore, Constitution Road frontage and Nancarrow Avenue frontage) and from Constitution Road down to the foreshore, including adjacent site are provided.	3
	5.	Perspectives of the development from the water, Constitution Road, Belmore Street and Bowden Street.	8 additional perspectives have now been provided	4
Height	6.	Spot RLs should be provided on the Concept Elevations which indicates the ground level at key locations on the site.	Additional levels have been shown on plans and elevations at known points on roads. As the site will require reshaping from existing altered topography exact levels mid block on most sites cannot be accurately stated due to existing built forms. It is not natural ground in any case due to benching to create building platforms.	3
	7.	RLs for all building heights to be nominated on the elevations (eg. the RL for the 3 storey component at the Constitution Road frontage has not been provided).	RLs for all building envelope heights have been nominated on the elevations and now include an additional 1 metre allowance to pending the results of detailed flood modelling of individual development or project applications. This will not rersult in any potential development yield as that is governed by the GFA maximums established by the Concept Plan.	3

Building separation	8.	While building separation has been provided on a stage by stage basis, a comprehensive plan for the whole Concept Plan should be provided demonstrating that separation between stages is consistent with the RFDC.	Building separations between stages and across streets meet with or exceed the RFDC recommendations. Internal separations between the buildings in the Stage 1 Development have been measured from the new ground plane established by the podium. In addition, suitable privacy screening will be included where necessary to address re entrant corners in envelopes. Building envelopes locations in all other development stages within the Concept Plan site have been revised to ensure appropriate RFDC compliant separations can be achieved from the refornmed ground level. In this regard, we note that Council's Draft LEP contains 3 definitions of ground level, one of which closely aligns the to concept Plan reformed ground plane linked to existing street levels.	
	9.	Stage boundaries and separation between all building elements (including elements within the same building) to be nominated on the building envelope plans and all elevations.	All development Stage boundaries and required building envelope separations have been shown on the relevant plans - Building Height Plan at Figure 13 and the Indicitive storeys Plan at Annexure 8	3 & 5 Figure 13 and Annexure 8
	10.	Confirmation on the height of approved buildings at 146 Bowden Street and the building separation provided between Stage 9 envelope and the approved development.	The building separation between Stage 9 building envelope and the approved development on 146 Bowden Street will comply with the RFDC separations and shown on relevant plans. Approved plans for 146 Bowden St also supplied.	5
	11.	Justification for separation that does not met the RFDC guidelines.	Internal separations between the buildings in the Stage 1 Development have been measured from the new ground plane established by the podium. In addition, suitable privacy screening will be included where necessary to address re entrant corners in envelopes. Building envelopes locations in all other development stages within the Concept Plan site have been revised to ensure appropriate RFDC compliant separations can be achieved from the refornmed ground level. In this regard, we note that Council's Draft LEP contains 3 definitions of ground level, one of which closely aligns the to concept Plan reformed ground plane linked to existing street levels.	Figure 13
	12.	Setbacks to isolated properties should be increased to at least half of the minimum building separation in line with the RFDC guideline. In particular, Stage 6 and Stage 8 – 3 metre setbacks should be increased to 6 metres.	Setbacks to isolated properties have now been increased to at least half of the maximum building separations in the RFDC guideline. Stage 6 is adjacent to a four storey commercial building with the shortest separation of 12m between the commercial building and the proposed envelope.	5 & 7 Figure 13

Open Space	14.	of publicly accessible open space will	The total area of publicly accessible open space within the Concept Plan site has been revised to now be 18,422sqm and now does not include any street frontage areas as requested. Areas of individual open spaces has again	8
	15.	be provided. The area of each open space area should be provided. Street setbacks should not be included in the open space	been provided in a new map. Noted	8
	16.	calculations.	Additional, hour by hour, shadowing assessment for June 21 9am to 3pm has now been provided demonstrating publicly accessible pedestrian corridors to the water will receive solar access between 9am - 11am. The Public foreshore plaza will receive solar access from 11am to past 3pm on June 21.	
Basement access	17.	Indicative basement entry for Church Street site to be nominated.	Indicative basement entry into site to be mid block off Parsonage Street.	
Flooding / Stormwater / Utilities	18.	Flood modelling to be provided to the Department. The department will forward to Council.	Data has been provided to Council	Annexures 14, 15 & 20
	19.	Concept Plans in Appendix 1 indicate	The stormwater easement does not pass under the building envelopes in the revised Concept Plan. The Concept Plan now provides a 16 metre wide easement to be dedicated to Council for area-wide stormwater infrastructure works.	10
	20.		The Shell Pipieline easement is located wholly off site. Previously submitted survey indicates Shell pipeline location on 146 Bowden Street. Surveyor advises no other properties affected. Minor adjustments have been made to Stage 9 building envelopes to allow for other easements in the area between 146 Bowden and the Concept Plan land.	12

Traffic	21.	A comprehensive response all traffic and transport concerns raised by Ryde Council, Transport for NSW and the Roads and Maritime Authority.	Further detailed traffic modelling of the Concept Plan, local and regional traffic, together with additional TMAP details.	Annexure 22
Road, pedestrian and cycleway apgrades	22.	Details on future upgrades of local streets and pedestrian and cycle routes as part of future applications including schematic designs.	Noted and incorporated into the Concept Plan.	Annexures 10 and 16
	23.	Details on the future upgrade of Constitution Road and works along the frontage of other properties which are not within the Concept Plan.	Noted and attached to the Concept Plan as Annexure 26 to the PPR	Annexure 26
	24.	Confirmation on existing/approved/ planned pedestrian links, in particular to Church Street.	All pedestrian links required in Council's Draft DCP have been included in the Concept Plan Landscape Plans at Annexure 10 to the PPR.	Annexure 10
ocial/Community Infrastructure and pen Space	25.	Further consideration of social/community infrastructure and active/passive recreation needs for future residents and whether these are met by the current provision in the area.	A separate Community Facilities and Open Space Needs Assessment has now been prepared and submitted by Cred social planners to inform the detail design and landuse makeup of Stages 2 to 10 of the Concept Plan.	Annexure 25
npacts on 146 Bowden Street	26.	A shadow analysis of the shadow impact of the development on the approved development at 146 Bowden Street demonstrating that units achieve a minimum of 2 hours solar access to living areas and private open space.	This has now been prepared and shadow diagrams contained later in this reponse. 146 Bowden Street was approved with habitable rooms and private open space being primarily oriented to the water views which is to the South. Accordingly the proposed envelopes have little or no impact.	11

1

APPENDIX 1 - SITE AREA FOR INDIVIDUAL LOTS:

TABLE 1. ALLOTMENTS OWNED OR CONTROLLED BY HOLDMARK PROPERTY GROUP OR ASSOCIATED COMPANIES

Lot	DP	Street Address	Owner	Site Area sqm
1	1072555	41- 45 Belmore Street Ryde 2112	Bayone Projects Pty Ltd	14,491
2	792836	116 Bowden Street Meadowbank 2114	AIT Trust	695
102	1037638	118-122 Bowden Street Meadowbank 2114	AIT Trust	15,766
2 1-2	550006 982743	2 Constitution Road and 7 & 9 Hamilton Crescent, Ryde	Exchanged with Ells Trading Pty Ltd, Garry Bozoghlian, Yervant Bozoghlian and Angel Bozoghlian and Holdmark Enterprises Pty Ltd Holdmark Enterprises Pty Ltd has obtained political disclosure form and permission to lodge from owner	2,058
1 1-2	104280 930584	4-6 Constitution Road Ryde 2112	Holdmark Enterprises Pty Ltd	1,669
1	713706	8 -14 Constitution Road Ryde 2112	Exchanged with Rowston. Holdmark Enterprises Pty Ltd has obtained political disclosure form and permission to lodge from owner	6,418
3	7130	16 Constitution Road Ryde 2112	AIT Trust	850
1-2	810552	18 Constitution Road Ryde	357 HPG Pty Limited	2,981
1	322641	6 Nancarrow Avenue Ryde 2112	Bayone Projects Pty Ltd	702
11	7130	8 Nancarrow Avenue Ryde 2112	Bayone Projects Pty Ltd	879
12	7130	10 Nancarrow Avenue Ryde 2112	Bayone Projects Pty Ltd	1,016
13 - 15	7130	12 - 16 Nancarrow Avenue Ryde 2112	Bayone Projects Pty Ltd	2,499

16	7130	18 Nancarrow Avenue Ryde 2112	Bayone Projects Pty Ltd	853
9	19585			
1	122205	37-53 Nancarrow	Nancarrow Property	10,175
1-7	19585	Avenue Ryde 2112	Investments Pty Limited	
10-17	19585			
10 14	738232			
13 - 14	809282	8 Parsonage Street Ryde 2112	Church Street Property Investments Pty Limited	3,952
7	851723	Nyde 2112		
100 15	738232			
1	703858	9- 10 Rothesay Avenue Ryde 2112	357 HPG Pty Ltd	1,504
18	7130	11 Rothesay Avenue Ryde 2112	357 HPG Pty Limited	815
	67,323sqm			
	(From Land and Property information service)			<i>5.</i> / 5. 55 4

APPENDIX 2

STAGE 1		
Stage. Block	GFA*	

4610 m ²
2333 m ²
6920 m ²
4104 m ²
2984 m²
3192 m ²
24143 m ²

STAGE 3		
Stage. Block	GFA*	
	4426 m2	

	0.71
3.1	4436 m ²
3.2	3357 m ²
3.3	6446 m ²
3.4	5063 m ²
3.5	2970 m ²
3.6	4206 m ²
	26477 m ²

STAGE 5		
Stage. Block	GFA*	
5.1	14189 m²	

7750 m²

21939 m²

ST	STAGE 7	
Stage. Block	GFA*	
7.1	4046 m ²	
7.2	8272 m ²	
7.3	2467 m ²	

1795 m²

16580 m²

STAGE 9	
Stage. Block	GFA*

9.1	382 m²
9.2	1667 m²
9.3	8394 m²
9.4	2247 m ²
9.5	5017 m ²
9.6	8227 m ²
	25935 m ²

1				

ST	AGE 2
Stage. Block	GFA*

2.1	5588 m ²
2.2	2047 m²
2.3	3359 m ²
2.4	7752 m²
	18747 m²

STAGE 4	
Stage. Block	GFA*

4.1	4816 m ²
4.2	12310 m ²
4.3	2409 m ²
4.4	3405 m ²
	22939 m²

STAGE 6	
Stage. Block	GFA*
6.1	2812 m ²

6.1	2812 m ²
6.2	5070 m ²
6.3	6484 m²
6.4	4678 m²
6.5	848 m²
	19892 m²

STAGE 8		
GFA*		

8.1	2270 m ²
8.2	3295 m ²
8.3	3994 m²
8.4	3185 m ²
8.5	4522 m ²
	17266 m ²

STA	AGE 10
Stage. Block	GFA*

10.1	2909 m²
10.2	3551 m ²
10.3	2024 m ²
	8484 m²

STAGE - T	STAGE - TOTAL GFA STA		OTAL GFA
Stage.Block	GFA*	Stage.Block	GFA*
1.1	4610 m ²	6.1	2812 m ²
1.2	2333 m ²	6.2	5070 m ²
1.3	6920 m²	6.3	6484 m²
1.4	4104 m²	6.4	4678 m²
1.5	2984 m²	6.5	848 m²
1.6	3192 m²	7.1	4046 m²
2.1	5588 m²	7.2	8272 m²
2.2	2047 m²	7.3	2467 m²
2.3	3359 m²	7.4	1795 m²
2.4	7752 m²	8.1	2270 m²
3.1	4436 m²	8.2	3295 m ²
3.2	3357 m ²	8.3	3994 m²
3.3	6446 m²	8.4	3185 m²
3.4	5063 m ²	8.5	4522 m²
3.5	2970 m²	9.1	382 m²
3.6	4206 m²	9.2	1667 m²
4.1	4816 m²	9.3	8394 m²
4.2	12310 m ²	9.4	2247 m ²
4.3	2409 m²	9.5	5017 m ²
4.4	3405 m²	9.6	8227 m²
5.1	14189 m²	10.1	2909 m²


7750 m²

2024 m² 202402 m²

10.2

10.3


3551 m²

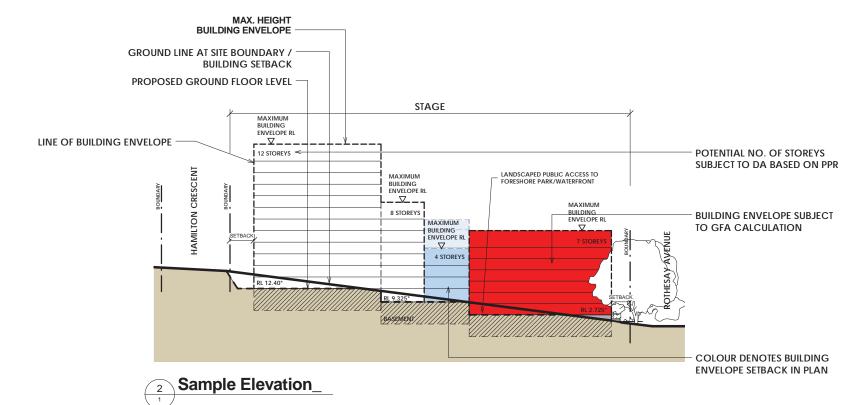

5.2

NOTE: *GFA CALCULATED AS 77.1% OF THE BUILDING ENVELOPE


LEGEND

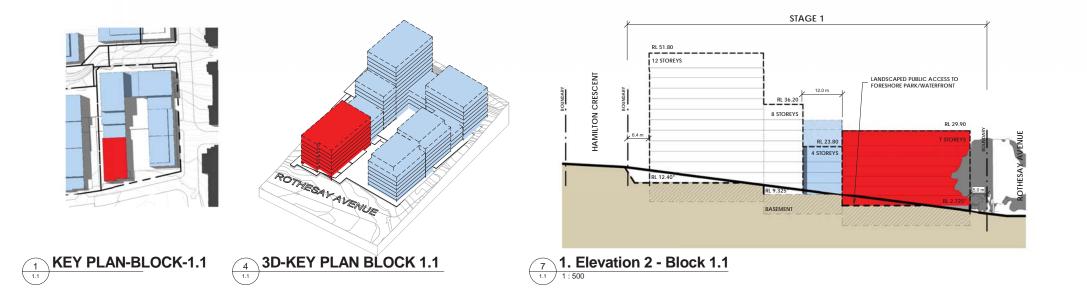


STAGE 1	STAGE 1 - BY BLOCK	
Block	GFA*	
1.1	4610 m ²	
1.2	2333 m ²	
1.3	6920 m ²	
1.4	4104 m ²	
1.5	2984 m²	
1.6	3192 m ²	
	24143 m ²	

BLO	BLOCK 1.1 - Area Schedule		
Block Name	Level	GFA*	
1.1	L1	187 m ²	
1.1	L2	632 m ²	
1.1	L3	632 m ²	
1.1	L4	632 m ²	
1.1	L5	632 m ²	
1.1	L6	632 m ²	
1.1	L7	632 m ²	
1.1	L8	633 m ²	
		4610 m ²	



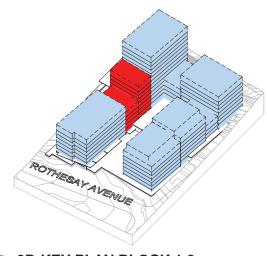

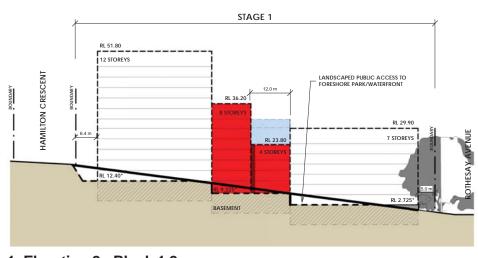


BLOCK 1.2 - Area Schedule		
Block Name Level		GFA*
1.2	L1	387 m ²
1.2	L2	387 m²
1.2	L3	387 m²
1.2	L4	387 m²
1.2	L5	196 m²
1.2	L6	196 m²
1.2	L7	196 m²
1.2	L8	196 m²
		2333 m²

1	2	KEY PLAN-BLOCK-1.2	
١	1.1 /		

5	3D-KEY	PLAN	BLOCK	1.2
1.1				

8 1. Elevation 2 - Block 1.2


4	T		
-	1	N	

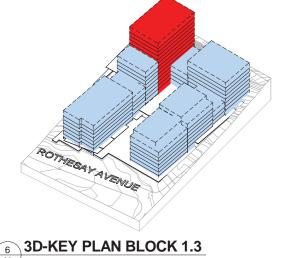


		STAGE 1	\
	RL 51.80		
_	12 STOREYS		
E C			LANDSCAPED PUBLIC ACCESS TO FORESHORE PARK/WATERFRONT
HAMILTON CRESCENT	BOUNDARY	RL 36.20	
i z	8	8 STOREYS	
6			RL 29.90
. ⊻) 6.4 m	RL 23.80	7 STOREYS
-		4 STOREYS	
	RL 12.40*		
	IL 12.40	RL 9.325*	7 STOREYS
		1212123////////////////////////////////	RL 2.725*
		BASEMENT	-
		- WW	

BLOCK 1.3 - Area Schedule		
Block Name	Level	GFA*
1.3	L1	577 m ²
1.3	L2	577 m ²
1.3	L3	577 m ²
1.3	L4	577 m ²
1.3	L5	577 m ²
1.3	L6	577 m ²
1.3	L7	577 m ²
1.3	L8	577 m ²
1.3	L9	577 m ²
1.3	L10	577 m ²
1.3	L11	577 m ²
1.3	L12	577 m ²
		6920 m ²

9 1. Elevation 2 - Block 1.3

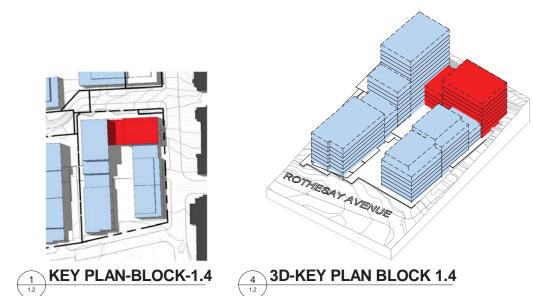

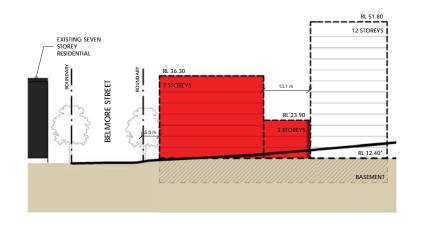



 * ASSUMED GROUND RL AS PER METHOD OF DEFINING HEIGHT (PPR REPORT, FIG 11, PG 28)


		Nancarrow Avenue - South - Block 1.4
1	1.2	1:500

STAGE 1 - BY BLOCK	
Block	GFA*
1.1	4610 m ²
1.2	2333 m²
1.3	6920 m²
1.4	4104 m²
1.5	2984 m²
1.6	3192 m²
	24143 m ²
1.6	0.00

BLOC	BLOCK 1.4 - Area Schedule	
Block Name	Level	GFA*
1.4	L1	708 m ²
1.4	L2	708 m ²
1.4	L3	708 m ²
1.4	L4	495 m²
1.4	L5	495 m²
1.4	L6	495 m²
1.4	L7	495 m ²
	•	•

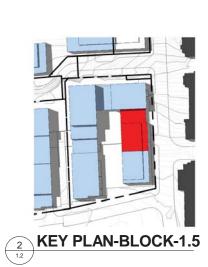

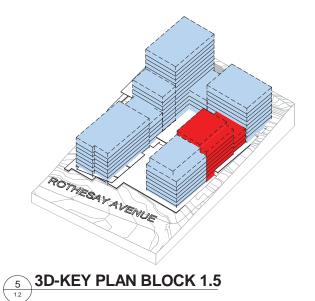


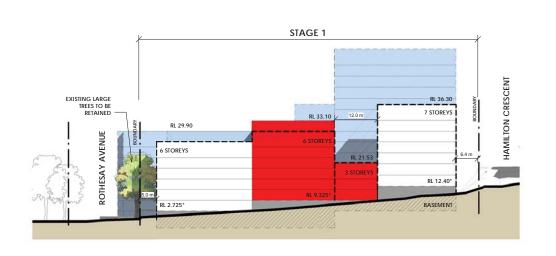


Block Name	Level	GFA*
	•	•
1.5	L1	595 m ²
1.5	L2	595 m ²
1.5	L3	595 m ²
1.5	L4	400 m ²
1.5	L5	400 m ²
1.5	L6	399 m²
	•	2984 m²

Belmore Street - Block 1.5



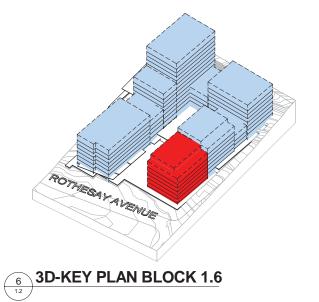


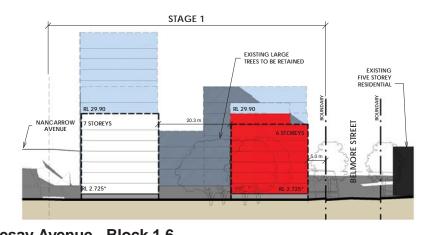

	Rothesay Avenue - Block 1.6	
1.2	1:500	


BLOCK 1.6 - Area Schedule	
Level	GFA*
L1	139 m²
L2	456 m ²
L3	456 m ²
L4	456 m²
L5	456 m²
L6	456 m²
L7	456 m²
L8	315 m ²
	3192 m²
	L1 L2 L3 L4 L5 L6 L7

APPENDIX 2 - FLOOR SPACE CALCULATIONS:

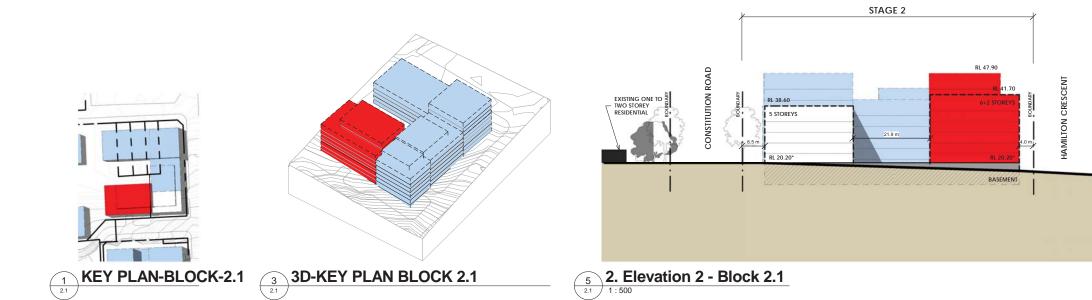


STAGE 2 - BY BLOCK	
Block	GFA*
2.1	5588 m²
2.2	2047 m ²
2.3	3359 m²
2.4	7752 m²
	18747 m²

BLOC	BLOCK 2.1 - Area Schedule	
Block Name	Level	GFA*
2.1	L1	776 m²
2.1	L2	776 m²
2.1	L3	776 m²
2.1	L4	776 m²
2.1	L5	776 m²
2.1	L6	776 m²
2.1	L7	466 m²
2.1	L8	466 m²
	•	5500 m2

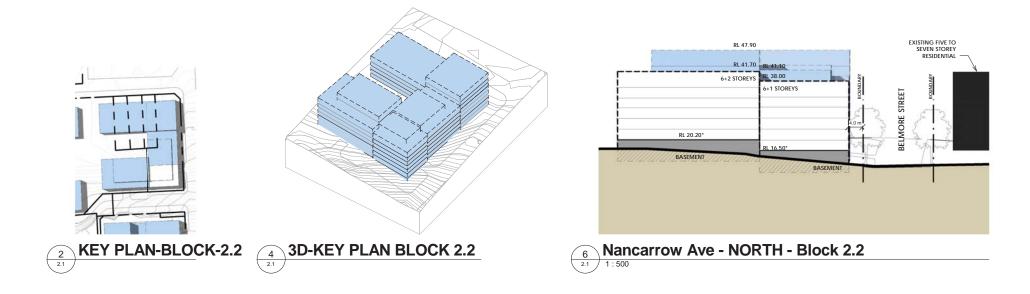


BLOCK 2.2 - Area Schedule		
Block Name	Level	GFA*
2.2	L1	341 m ²
2.2	L2	341 m ²
2.2	L3	341 m ²
2.2	L4	341 m²
2.2	L4	341 m²
2.2	L6	341 m²
		2047 m ²

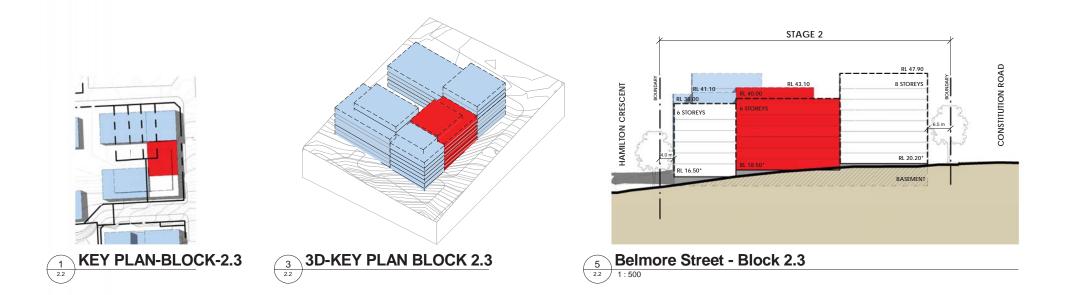


STAGE 2 - BY BLOCK	
Block	GFA*
2.1	5588 m²
2.2	2047 m ²
2.3	3359 m²
2.4	7752 m²
	18747 m²


BLOCK 2.3 - Area Schedule		
Block Name	Level	GFA*
2.3	L1	560 m ²
2.3	L2	560 m ²
2.3	L3	560 m ²
2.3	L4	560 m ²
2.3	L5	560 m ²
2.3	L6	560 m ²
		3350 m²

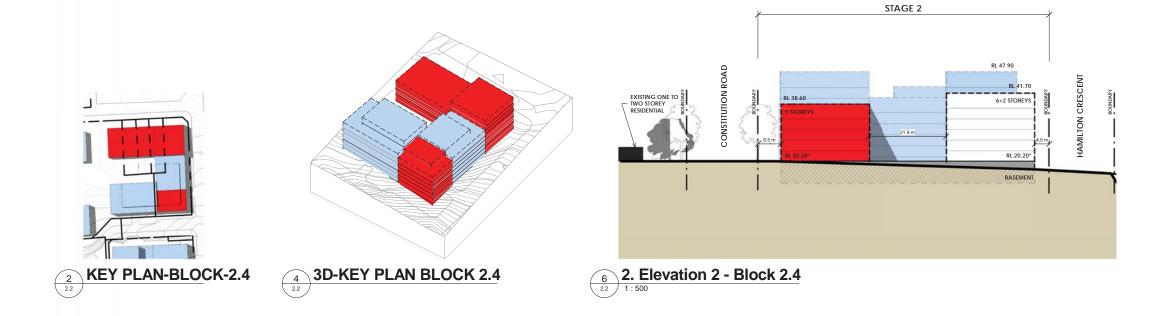

BLOCK 2.4 - Area Schedule		
Block Name	Level	GFA*
2.4	L1	1261 m ²
2.4	L2	1261 m ²
2.4	L3	1261 m ²
2.4	L4	1261 m ²
2.4	L5	1261 m²
2.4	L6	483 m²
2.4	L6	483 m²
2.4	L8	483 m²
		7752 m²

APPENDIX 2 - FLOOR SPACE CALCULATIONS:

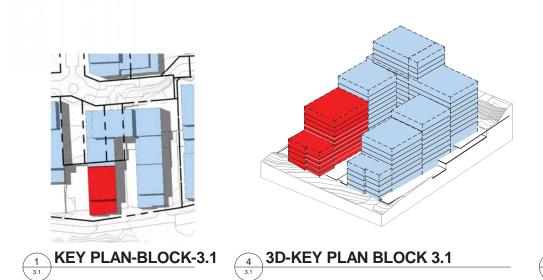


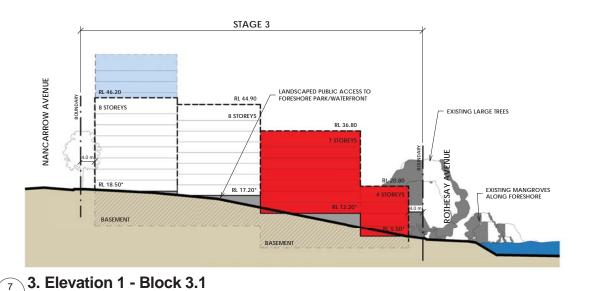

STAGE 3 - BY BLOCK			
Block	GFA*		
3.1	4436 m²		
3.2	3357 m ²		
3.3	6446 m²		
3.4	5063 m ²		
3.5	2970 m ²		
3.6	4206 m²		
	26477 m²		


BLOCK 3.1 - Area Schedule		
Block Name	Level	GFA*
		_
3.1	L1	733 m ²
3.1	L2	733 m²
3.1	L3	733 m²
3.1	L4	733 m²
3.1	L5	502 m ²
3.1	L6	502 m ²
3.1	L7	502 m ²
		4436 m ²

KEY PLAN-BLOCK-3.2	5 3D-KEY PLAN BLOCK 3.2

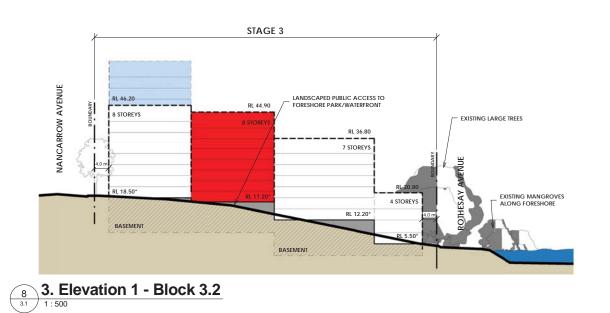

BLOCK 3.2 - Area Schedule		
Block Name	Level	GFA*
3.2	L1	420 m ²
3.2	L2	420 m ²
3.2	L3	420 m²
3.2	L4	420 m ²
3.2	L5	420 m ²
3.2	L6	420 m²
3.2	L7	420 m ²
3.2	L8	420 m²
	•	3357 m²

KEY PLAN-BLOCK-3.3	6 3D-KEY PLAN BLOCK 3.3

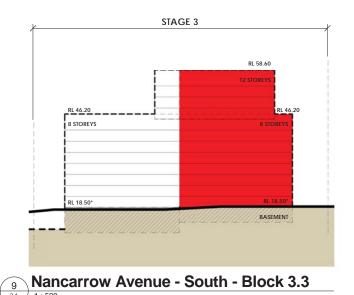


BLOCK 3.3 - Area Schedule		
Block Name	Level	GFA*
	I	
3.3	L1	567 m ²
3.3	L2	567 m ²
3.3	L3	567 m ²
3.3	L4	567 m ²
3.3	L5	567 m ²
3.3	L6	567 m ²
3.3	L7	567 m ²
3.3	L8	567 m ²
3.3	L9	478 m²
3.3	L10	478 m²
3.3	L11	478 m²
3.3	L12	478 m²
		6446 m ²

JULY 2012 | REV 2

PLACE DESIGN GROUP

APPENDIX 2 - FLOOR SPACE CALCULATIONS:

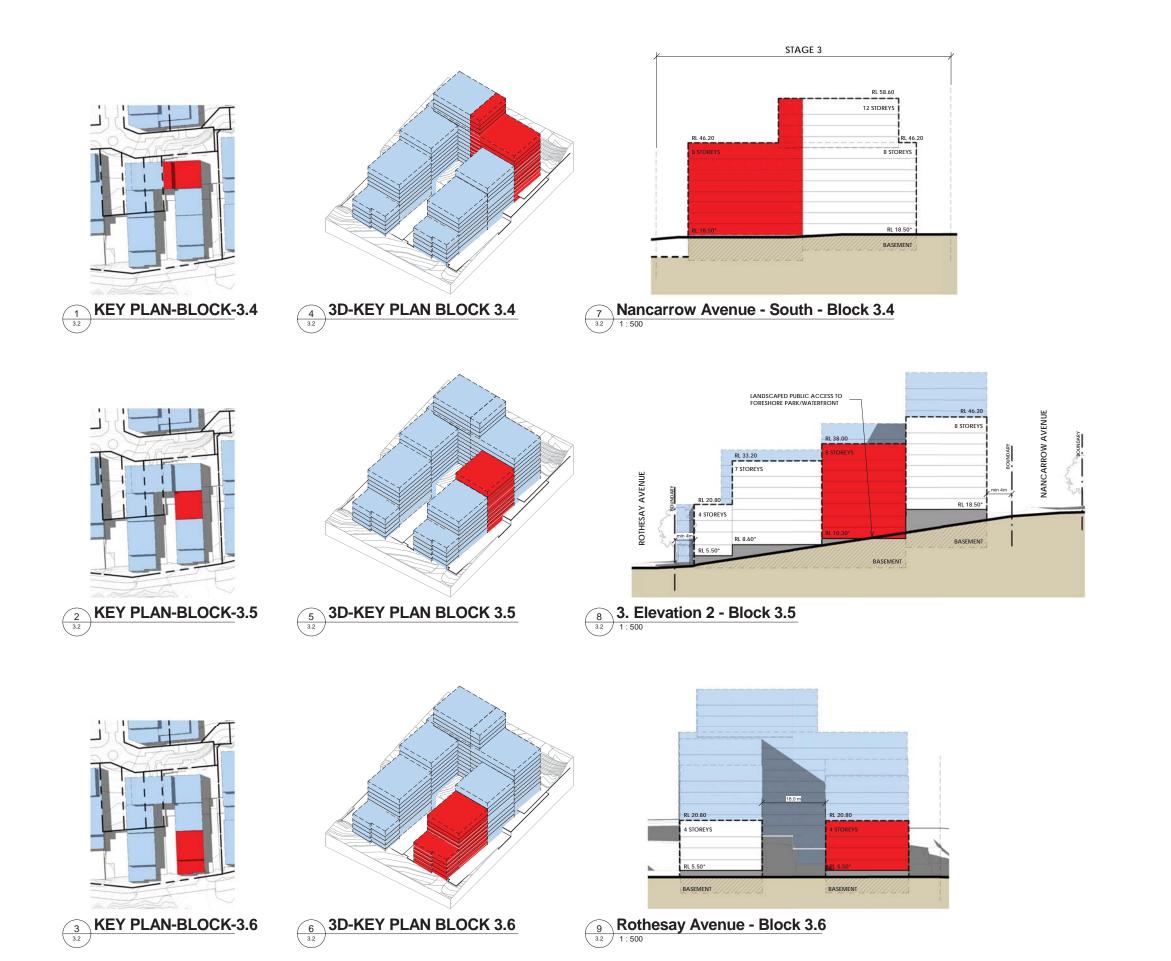



STAGE 3 - BY BLOCK		
Block	GFA*	
3.1	4436 m²	
3.2	3357 m ²	
3.3	6446 m²	
3.4	5063 m ²	
3.5	2970 m ²	
3.6	4206 m²	
	26 477 m2	

BLOCK 3.4 - Area Schedule		
Block Name	Level	GFA*
3.4	L1	571 m ²
3.4	L2	571 m ²
3.4	L3	571 m ²
3.4	L4	571 m²
3.4	L5	571 m²
3.4	L6	571 m²
3.4	L7	571 m²
3.4	L8	571 m²
3.4	L9	124 m²
3.4	L10	124 m²
3.4	L11	122 m²
3.4	L12	122 m²
	•	5063 m ²

BLOCK 3.5 - Area Schedule		
Block Name	Level	GFA*
3.5	L1	424 m ²
3.5	L2	424 m²
3.5	L3	424 m²
3.5	L4	424 m²
3.5	L5	424 m²
3.5	L6	424 m²
3.5	L7	
3.5	L8	424 m²
		2970 m ²


BLOCK 3.6 - Area Schedule		
Block Name	Level	GFA*
3.6	L1	660 m ²
3.6	L2	660 m ²
3.6	L3	660 m ²
3.6	L4	658 m ²
3.6	L5	660 m ²
3.6	L5	454 m²
3.6	L7	454 m²
		4206 m ²

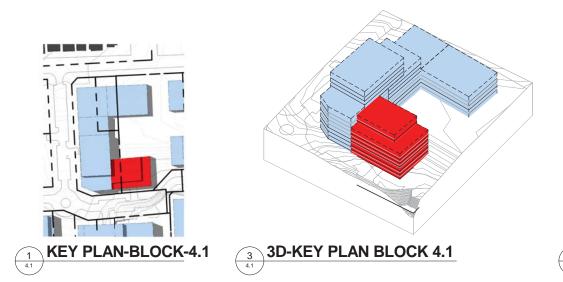


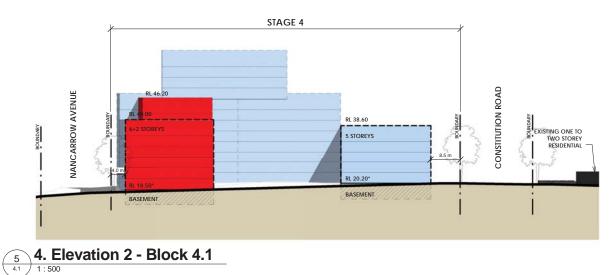


STAGE 4 - BY BLOCK		
Block	Block GFA*	
4.1	4816 m ²	
4.2	12310 m ²	
4.3	2409 m²	
4.4	3405 m ²	
	22030 m2	

BLOC	BLOCK 4.1 - Area Schedule	
Block Name	Level	GFA*
4.1	L1	669 m ²
4.1	L2	669 m²
4.1	L3	669 m ²
4.1	L4	669 m²
4.1	L5	669 m ²
4.1	L6	669 m ²
4.1	L7	401 m ²
4.1	L8	401 m²
		4816 m ²

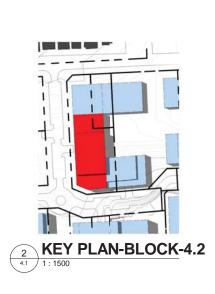


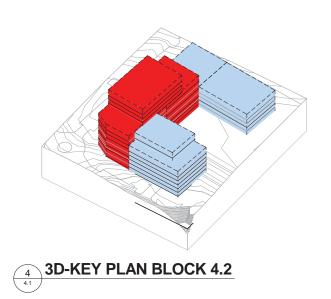

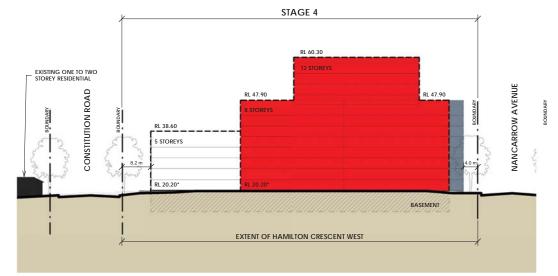


Hamilton Crescent - East - Block 4.2


BLOCK 4.2 - Area Schedule		
Block Name	Level	GFA*
4.2	L1	1201 m ²
4.2	L2	1201 m ²
4.2	L3	1201 m ²
4.2	L4	1201 m ²
4.2	L5	1201 m ²
4.2	L6	1201 m ²
4.2	L7	1201 m ²
4.2	L8	1201 m ²
4.2	L9	675 m ²
4.2	L10	675 m ²
4.2 4.2	L11	675 m²
4.2	L12	675 m²
		12310 m ²

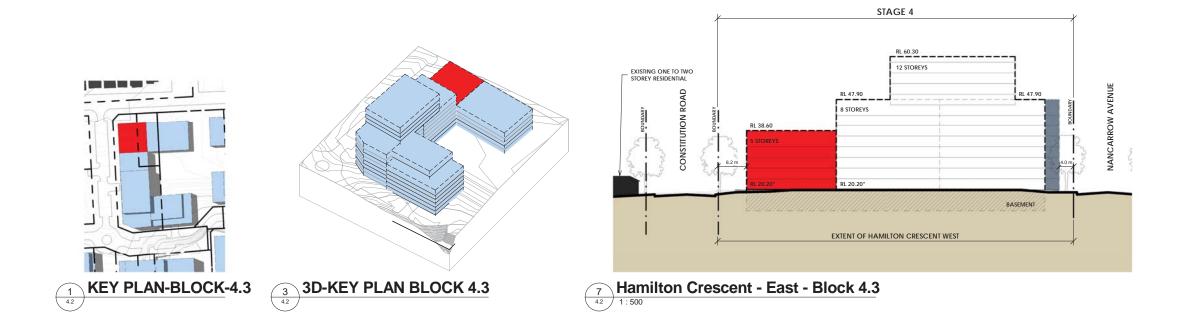


STAGE 4 - BY BLOCK		
Block	Block GFA*	
4.1	4816 m²	
4.2	12310 m ²	
4.3	2409 m ²	
4.4	3405 m ²	
	22030 m2	

BLOC	K 4.3 - Are	a Schedule
Block Name	Level	GFA*
4.3	L1	482 m²
4.3	L2	482 m²
4.3	L3	482 m²
4.3	L4	482 m²
4.3	L5	482 m²
		2409 m²

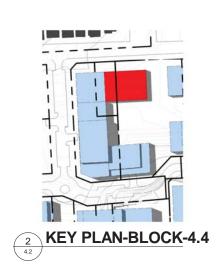


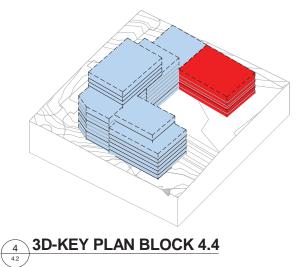


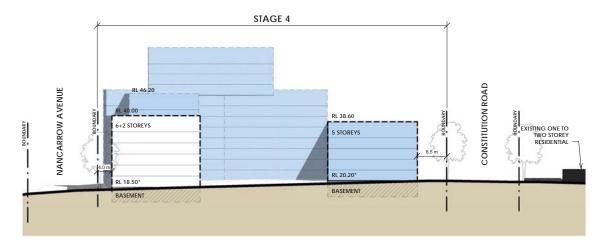


BLOCK 4.4 - Area Schedule		
Block Name	Level	GFA*
4.4	L1	681 m ²
4.4	L2	681 m ²
4.4	L3	681 m ²
4.4	L4	681 m ²
4.4	L5	681 m ²
		3405 m ²

6 4. Elevation 2 - Block 4.4

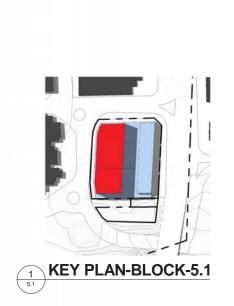


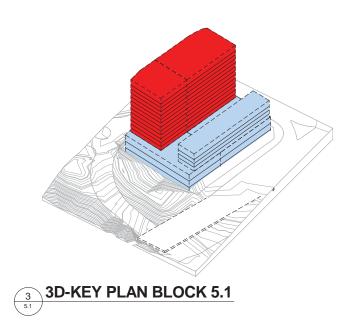


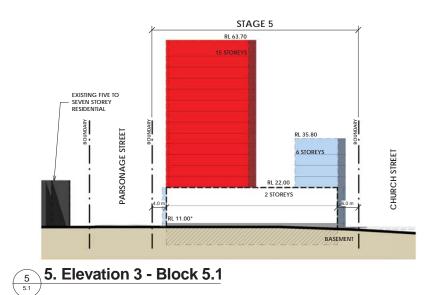


STAGE 5	STAGE 5 - BY BLOCK	
Block	GFA*	
5.1	14189 m²	
5.2	7750 m²	
	21939 m²	

BLOC	CK 5.1 - Area Schedule	
Block Name	Level	GFA*
5.1	L3	1092 m ²
5.1	L4	1092 m ²
5.1	L5	1091 m ²
5.1	L6	1091 m²
5.1	L7	1091 m ²
5.1	L8	1091 m ²
5.1	L9	1091 m²
5.1	L10	1092 m²
5.1	L11	1092 m²
5.1	L12	1091 m ²
5.1	L13	1091 m²
5.1	L14	1092 m²
5.1	L15	1091 m²
	•	14189 m²

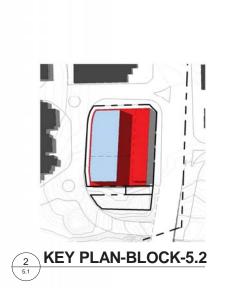

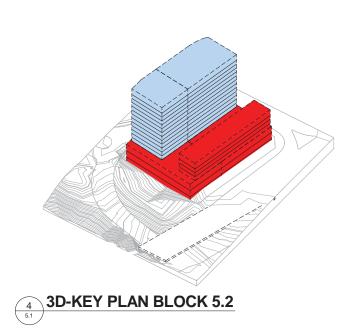

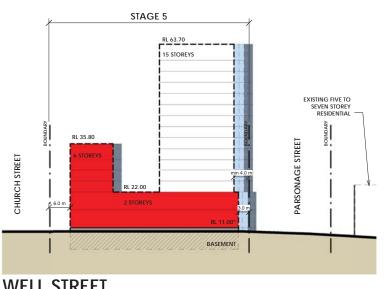


WELL STREET * ASSUMED GROUND RL AS PER METHOD OF DEFINING HEIGHT (PPR REPORT, FIG 11, PG 28)


WELL STREET - Block 5.2

BLOC	K 5.2 - Are	a Schedule
Block Name	Level	GFA*
5.2	L1	2483 m ²
5.2	L2	2483 m ²
5.2	L3	557 m ²
5.2	L4	557 m ²
5.2	L5	557 m ²
5.2	L6	557 m ²
5.2	L7	557 m ²
		7750 m²

preferred project report JULY 2012 | REV 2 PLACE DESIGN GROUP

ROBERTSON+MARKS ARCHITECTS | 18

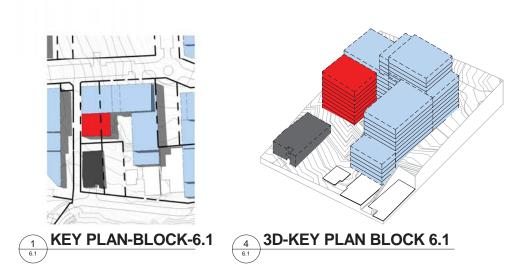


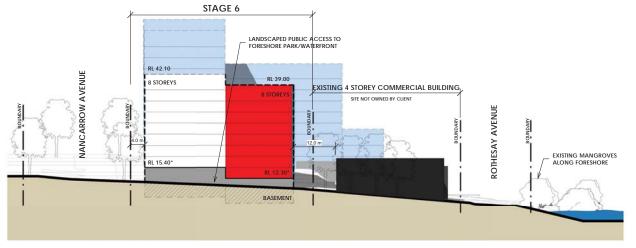



STAGE 6	STAGE 6 - BY BLOCK	
Block	GFA*	
6.1	2812 m²	
6.2	5070 m ²	
6.3	6484 m²	
6.4	4678 m²	
6.5	848 m²	
	19892 m²	

BLOC	K 6.1 - Ar	ea Schedule
Block Name	Level	GFA*
	•	•
6.1	L1	352 m ²
6.1	L2	352 m ²
6.1	L3	352 m ²
6.1	L4	352 m²
6.1	L5	352 m ²
6.1	L6	352 m²
6.1	L7	352 m²
6.1	L8	352 m²
		2812 m2

7	6. Elevation 2 - Block 6.1
6.1	1 · 500

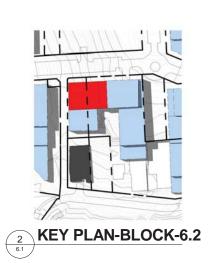


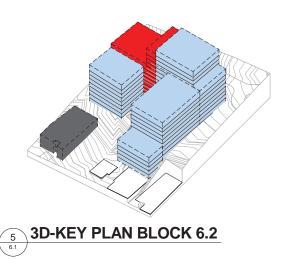

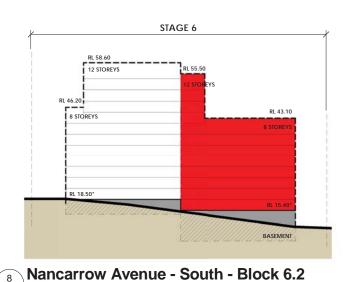

BLOCK 6.2 - Area Schedule		
Block Name	Level	GFA*
6.2	L1	574 m ²
6.2	L2	574 m ²
6.2	L3	574 m ²
6.2	L4	574 m²
6.2	L5	574 m ²
6.2	L6	574 m²
6.2	L7	574 m²
6.2	L8	574 m²
6.2	L9	120 m²
6.2	L10	120 m²
6.2	L11	120 m²
6.2	L12	120 m²
		5070 m ²


3 KEY PLAN-BLOCK-6.3	6 3D-KEY PLAN BLOCK 6.3

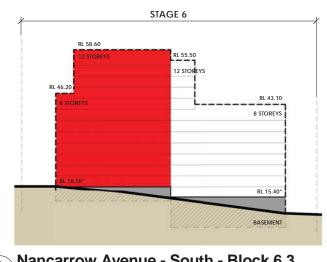


9	Nancarrow Avenue - South - Block 6.3
6.1	1:500

BLOCK 6.3 - Area Schedule		
Block Name	Level	GFA*
6.3	L1	569 m ²
6.3	L2	569 m ²
6.3	L3	569 m ²
6.3	L4	569 m ²
6.3	L5	569 m ²
6.3	L6	569 m ²
6.3	L7	569 m ²
6.3	L8	569 m ²
6.3	L9	483 m²
6.3	L10	483 m²
6.3	L11	483 m²
6.3	L12	483 m²
	•	6484 m²


APPENDIX 2 - FLOOR SPACE CALCULATIONS:

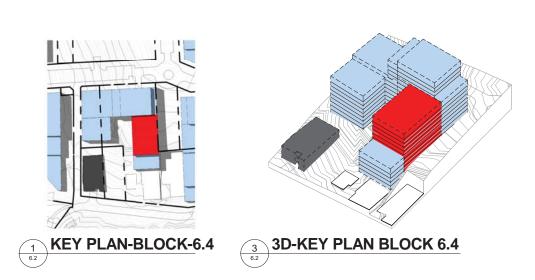


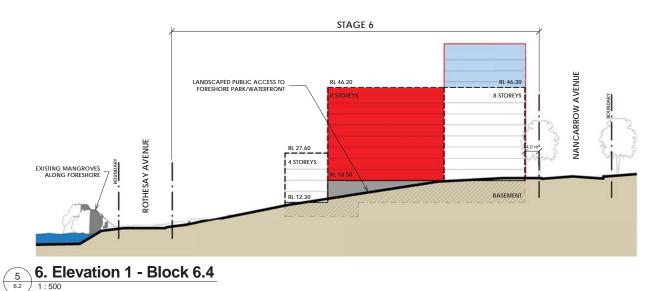


STAGE 6	STAGE 6 - BY BLOCK		
Block	GFA*		
6.1	2812 m ²		
6.2	5070 m ²		
6.3	6484 m²		
6.4	4678 m²		
6.5	848 m²		
	10000 3		

BLUC	BLOCK 6.4 - Area Scriedule	
Block Name	Level	GFA*
6.4	L1	585 m ²
6.4	L2	585 m ²
6.4	L3	585 m ²
6.4	L4	585 m ²
6.4	L5	585 m ²
6.4	L6	585 m ²
6.4	L7	585 m²
6.4	L8	585 m²
		4678 m²

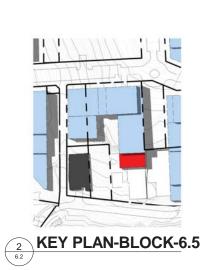

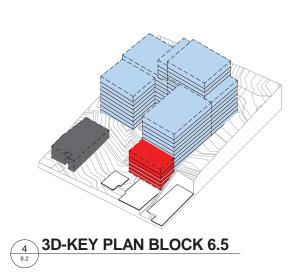


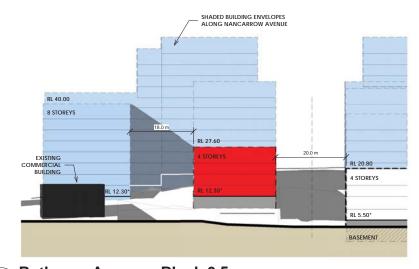



BLUC	N 6.5 - Are	a Schedule
Block Name	Level	GFA*
6.5	L1	212 m ²
6.5	L2	212 m ²
6.5	L3	212 m ²
6.5	L4	212 m ²
		848 m²

Rothesay Avenue - Block 6.5

APPENDIX 2 - FLOOR SPACE CALCULATIONS:

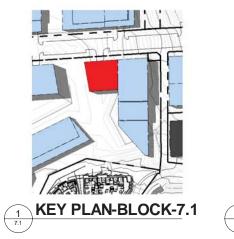

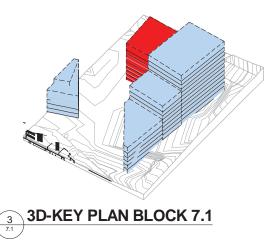

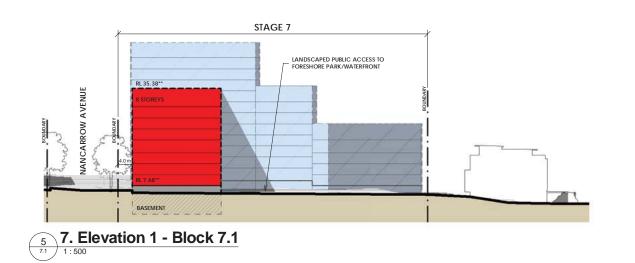



STAGE 7 - BY BLOCK	
Block	GFA*
7.1	4046 m²
7.2	8272 m²
7.3	2467 m²
7.4	1795 m²
	16580 m²

Block Name	Level	GFA*
7.1	L1	506 m ²
7.1	L2	506 m ²
7.1	L3	506 m ²
7.1	L4	506 m ²
7.1	L5	506 m ²
7.1	L6	506 m ²
7.1	L7	506 m ²
7.1	L8	506 m ²
		10.10 0

BLOCK 7.1 - Area Schedule



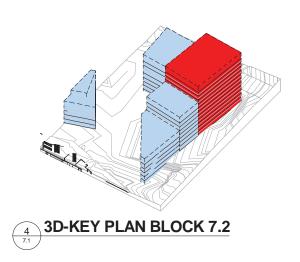


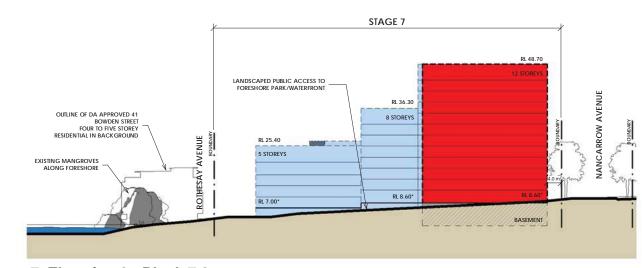



BLOC	K 7.2 - Ar	ea Schedule
Block Name	Level	GFA*
7.2	L2	689 m²
7.2	L3	689 m²
7.2	L4	689 m²
7.2	L5	689 m²
7.2	L6	689 m²
7.2	L7	689 m²
7.2	L8	689 m²
7.2	L9	689 m²
7.2	L10	689 m²
7.2	L11	689 m²
7.2	L12	689 m²
7.2	L13	689 m²
	•	8272 m²

7. Elevation 2 - Block 7.2

preferred project report JULY 2012 | REV 2

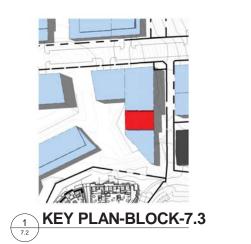


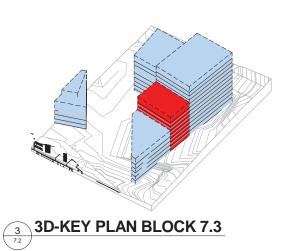


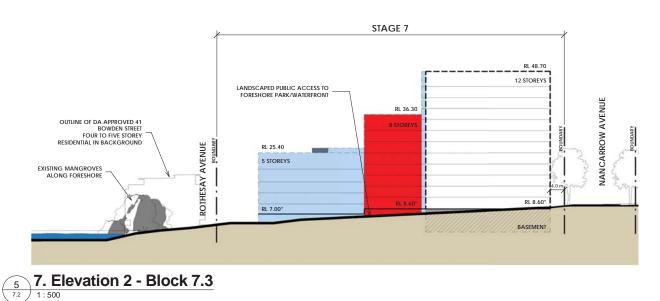


STAGE 7	STAGE 7 - BY BLOCK		
Block	GFA*		
7.1	4046 m ²		
7.2	8272 m²		
7.3	2467 m²		
7.4	1795 m²		
	16580 m ²		

BLOC	BLOCK 7.3 - Area Schedule		
Block Name	Level	GFA*	
7.3	L1	308 m ²	
7.3	L2	308 m ²	
7.3	L3	308 m ²	
7.3	L4	308 m²	
7.3	L5	308 m ²	
7.3	L6	308 m ²	
7.3	L7	308 m ²	
7.3	L8	308 m ²	
	•	0.407 2	

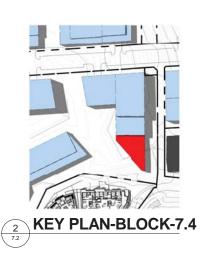

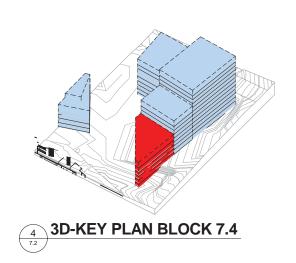


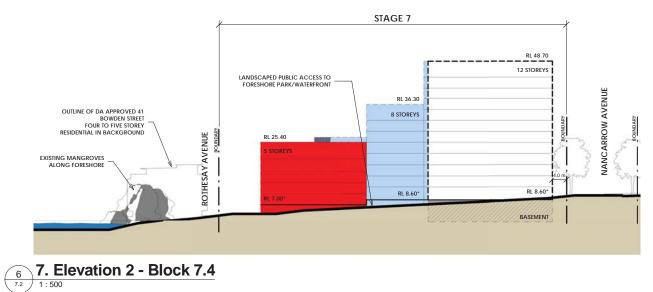


BLOCK 7.4 - Area Schedule		
Block Name	Level	GFA*
7.4	L1	359 m²
7.4	L2	359 m²
7.4	L3	359 m²
7.4	L4	359 m²
7.4	L5	359 m²
	•	1795 m²

JULY 2012 | REV 2


APPENDIX 2 - FLOOR SPACE CALCULATIONS:

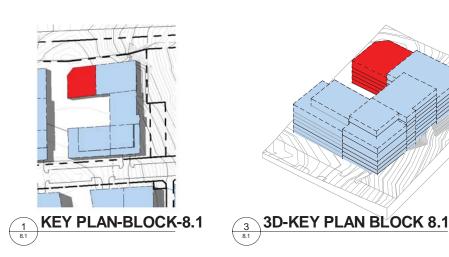


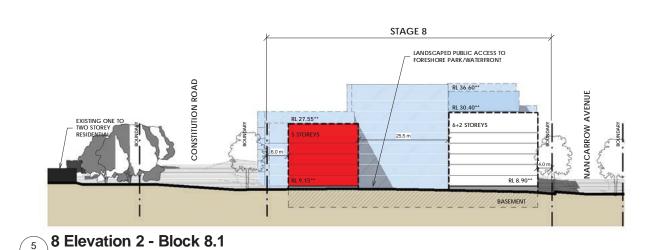


STAGE 8 - BY BLOCK		
Block	GFA*	
8.1	2270 m ²	
8.2	3295 m²	
8.3	3994 m²	
8.4	3185 m²	
8.5	4522 m²	
	17266 m²	

BLOC	K 8.1 - Are	a Schedule
Block Name	Level	GFA*
8.1	L1	454 m ²
8.1	L2	454 m ²
8.1	L3	454 m²
8.1	L4	454 m²
8.1	L5	454 m²
		2270 m ²

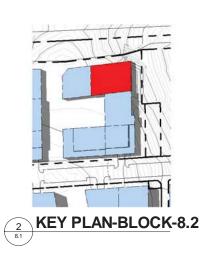


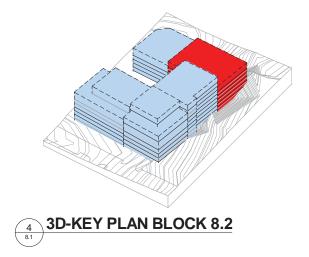


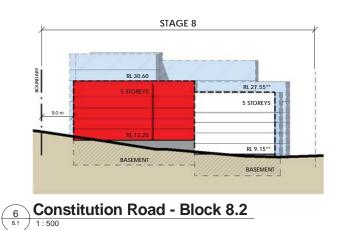


BLOCK 8.2 - Area Schedule		
Block Name	Level	GFA*
8.2	L1	659 m ²
8.2	L2	659 m²
8.2	L3	659 m²
8.2	L4	659 m²
8.2	L5	659 m²
		3295 m²

APPENDIX 2 - FLOOR SPACE CALCULATIONS:

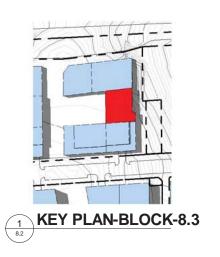

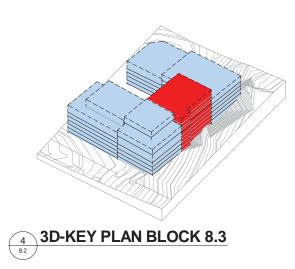

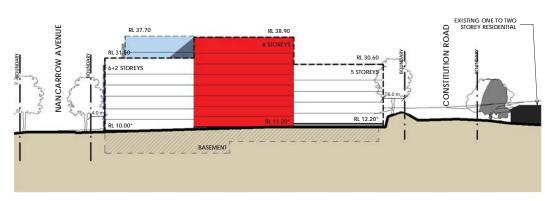

STAGE 8 - BY BLOCK				
Block	GFA*			
8.1	2270 m ²			
8.2	3295 m²			
8.3	3994 m²			
8.4	3185 m²			
8.5	4522 m²			
	17266 m²			

BLOCK 8.3 - Area Schedule		
Block Name	Level	GFA*
8.3	L1	499 m²
8.3	L2	499 m²
8.3	L3	499 m²
8.3	L4	499 m²
8.3	L5	499 m²
8.3	L6	499 m²
8.3	L7	499 m²
8.3	L16	499 m²
		2004 m2

7	8. Elevation 1 - Block 8.3
8.2	1:500

<i>y</i> /


RL 36.60**	RL 37.70	
RL 30.40**	01.31.50	
6+2 STOREYS	6+2 STOREYS	
		9.0 m
RL 8.90**	RL 10.00*	_
BASEMENT	BASEMENT	

BLOCK 8.4 - Area Schedule			
Level	GFA*		
L1	483 m²		
L2	483 m²		
L3	483 m²		
L4	483 m²		
L5	483 m²		
L6	483 m²		
L7			
L8	290 m²		
	3185 m²		
	Level L1 L2 L3 L4 L5 L6 L7		


	Nancarrow Ave - NORTH - Block 8.4
8.2	1:500

	4-14	H==	
	-		
		T!\\\\	
	<u></u>		
-	-	PI	
3 KEY	PLAN-	BLOCK-8	3.
8.2 1 : 1500			

KEY PLAN-BLOCK-8.4

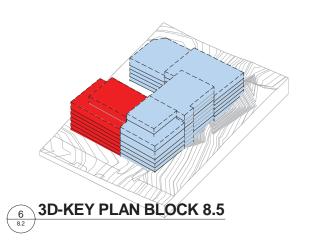


5 3D-KEY PLAN BLOCK 8.4

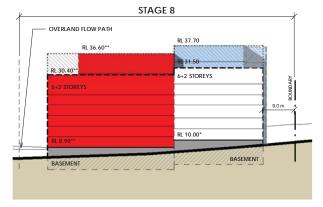


9 Nancarrow Ave - NORTH - Block 8.5

BLOC	BLOCK 8.5 - Area Schedule				
Block Name	Level	GFA*			
8.5	L1	685 m²			
8.5	L2	685 m²			
8.5	L3	685 m²			
8.5	L4	685 m²			
8.5	L5	685 m²			
8.5	L6	685 m²			
8.5	L7				
8.5	L8	411 m²			
		4522 m²			

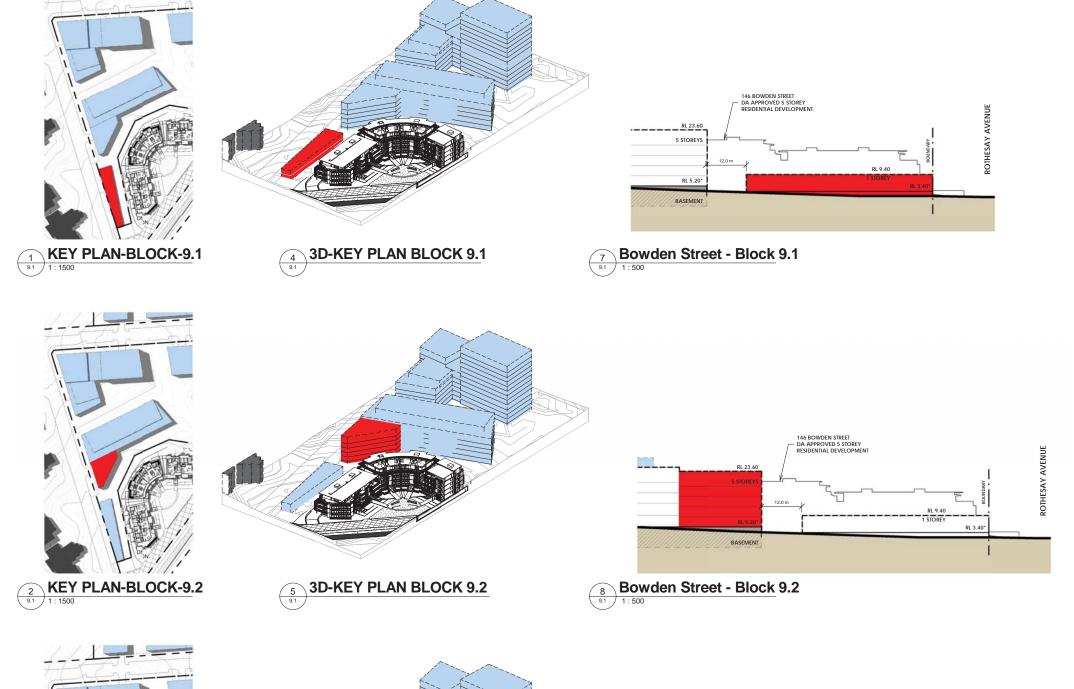

STAGE 9 - BY BLOCK Block GFA* 9.1 382 m² 9.2 1667 m² 9.3 8394 m² 9.4 2247 m² 9.5 5017 m² 9.6 8227 m² 25935 m² BLOCK 9.1 - Area Schedule Block Name Level GFA* 9.1 L1 382 m² 382 m² 382 m² 9.2 L1 333 m² 9.2 L2 333 m² 9.2 L4 333 m² 9.2 L4 333 m² 9.2 L5 333 m² 9.2 L5 333 m² 9.2 L667 m²	Block GFA*					
9.1 382 m² 9.2 1667 m² 9.3 8394 m² 9.4 2247 m² 9.5 5017 m² 9.6 8227 m² 25935 m² BLOCK 9.1 - Area Schedule Block Level GFA* 382 m² 382 m² 382 m² 9.2 L1 333 m² 9.2 L4 333 m² 9.2 L4 333 m² 9.2 L4 333 m² 9.2 L5 333 m²	9.1 382 m² 9.2 1667 m² 9.3 8394 m² 9.4 2247 m² 9.5 5017 m² 9.6 8227 m² 25935 m² BLOCK 9.1 - Area Schedule Block Level GFA* 9.1 L1 382 m² 382 m² 382 m² 9.2 L1 333 m² 9.2 L3 333 m² 9.2 L4 333 m² 9.2 L5 333 m² 9.2 L67 m²					<u>C</u>
9.2 1667 m² 9.3 8394 m² 9.4 2247 m² 9.5 5017 m² 9.6 8227 m² 25935 m² BLOCK 9.1 - Area Schedule Block Name	9.2				J. 7.	
9.3 8394 m² 9.4 2247 m² 9.5 5017 m² 9.6 8227 m² 25935 m² BLOCK 9.1 - Area Schedule Block Name Level GFA* 9.1 L1 382 m² 382 m² 382 m² 9.2 L1 333 m² 9.2 L3 333 m² 9.2 L4 333 m² 9.2 L4 333 m² 9.2 L5 333 m²	9.3 8394 m² 9.4 2247 m² 9.5 5017 m² 9.6 8227 m² 25935 m² BLOCK 9.1 - Area Schedule Block Name Level GFA* 382 m² 382 m² 382 m² 9.2 L1 333 m² 9.2 L3 333 m² 9.2 L4 333 m² 9.2 L5 333 m² 9.2 L5 333 m² 9.2 L5 333 m² 1667 m²					
9.4 2247 m² 9.5 5017 m² 9.6 8227 m² 25935 m² BLOCK 9.1 - Area Schedule Block Level GFA* 9.1	9.4 2247 m² 9.5 5017 m² 25935 m² 25935 m² 25935 m² 25935 m² 25935 m² 2 382 m² 382 m²					
9.5 5017 m² 9.6 8227 m² 25935 m² BLOCK 9.1 - Area Schedule Block Level GFA* 9.1 L1 382 m² 382 m² 382 m² 1 382 m² 2 L1 333 m² 9.2 L2 333 m² 9.2 L4 333 m² 9.2 L4 333 m² 9.2 L5 333 m²	BLOCK 9.1 - Area Schedule Block Name Level GFA* 9.1 L1 382 m² 382 m² 382 m² 382 m² 382 m² 9.2 L1 333 m² 9.2 L2 333 m² 9.2 L4 333 m² 9.2 L4 333 m² 9.2 L5 333 m² 9.2 L667 m²					_
SECOCK 9.1 - Area Schedule Block Level GFA* SI	BLOCK 9.1 - Area Schedule Block Name Level GFA* 9.1			50	17 m ²	\dashv
BLOCK 9.1 - Area Schedule Block Name Level GFA* 9.1	BLOCK 9.1 - Area Schedule Block Name Level GFA* 9.1 L1					
Block Name Level GFA*	Block Name Level GFA* 9.1			25	935 m²	
Block Name Level GFA*	Block Name Level GFA* 9.1					
Name Level GFA* 9.1 L1 382 m² 382 m² 382 m² 382 m² 19.2 L1 333 m² 9.2 L2 333 m² 9.2 L4 333 m² 9.2 L4 333 m² 9.2 L5 333 m²	BLOCK 9.2 - Area Schedule	BLOC	K 9.1 -	Area	Sched	lule
9.1	BLOCK 9.2 - Area Schedule Block Rame Level GFA* 9.2					
BLOCK 9.2 - Area Schedule Block Name Level GFA* 9.2	BLOCK 9.2 - Area Schedule Block Name Level GFA* 9.2 L1 333 m² 9.2 L2 333 m² 9.2 L3 333 m² 9.2 L4 333 m² 9.2 L4 333 m² 9.2 L5 333 m² 1667 m²	Name	Lev	el	GF/	A*
BLOCK 9.2 - Area Schedule Block Name Level GFA* 9.2	BLOCK 9.2 - Area Schedule Block Name Level GFA* 9.2	0.4	1.4		000 2	
BLOCK 9.2 - Area Schedule	BLOCK 9.2 - Area Schedule Block Name Level GFA*	9.1	L1			
Block Name Level GFA*	Block Name Level GFA* 9.2					
9.2 L1 333 m ² 9.2 L2 333 m ² 9.2 L3 333 m ² 9.2 L4 333 m ² 9.2 L4 333 m ² 9.2 L5 333 m ²	9.2 L1 333 m ² 9.2 L2 333 m ² 9.2 L3 333 m ² 9.2 L4 333 m ² 9.2 L5 333 m ² 9.2 L6 1667 m ²					
9.2 L2 333 m² 9.2 L3 333 m² 9.2 L4 333 m² 9.2 L5 333 m²	9.2 L2 333 m ² 9.2 L3 333 m ² 9.2 L4 333 m ² 9.2 L5 333 m ² 1667 m ²	Block				
9.2 L3 333 m ² 9.2 L4 333 m ² 9.2 L5 333 m ²	9.2 L3 333 m ² 9.2 L4 333 m ² 9.2 L5 333 m ² 1667 m ²	Block Name	Lev	el	GF	A*
9.2 L4 333 m ² 9.2 L5 333 m ²	9.2 L4 333 m ² 9.2 L5 333 m ² 1667 m ²	Block Name	Lev L1	el	GF /	A *
9.2 L5 333 m ²	9.2 L5 333 m ² 1667 m ²	9.2 9.2	L1 L2	el	GF / 333 m ² 333 m ²	A*
	1667 m²	9.2 9.2 9.2	L1 L2 L3	el	GF / 333 m ² 333 m ² 333 m ²	A *
1007 115		9.2 9.2 9.2 9.2	L1 L2 L3 L4	rel	GF / 333 m ² 333 m ² 333 m ²	A*
		9.2 9.2 9.2 9.2	L1 L2 L3 L4	rel	333 m ² 333 m ² 333 m ² 333 m ² 333 m ²	A*

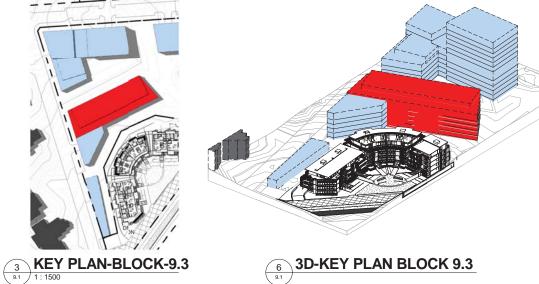



18.0 m	RL 23.90 5 STOREYS	RL 23.60 5 STOREYS	RESIDENTIAL DEVELOPMEN
	RL 5.50*	RL 5.20*	12.0 m

BLOC	K 9.3 - Are	a Schedule
Block Name	Level	GFA*
9.3	L1	1483 m ²
9.3	L2	1483 m²
9.3	L3	1483 m²
9.3	L4	1483 m²
9.3	L5	1483 m²
9.3	L6	979 m²
		8394 m²

Bowden Street - Block 9.3

APPENDIX 2 - FLOOR SPACE CALCULATIONS:

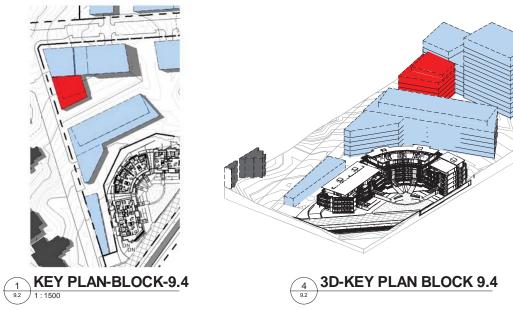


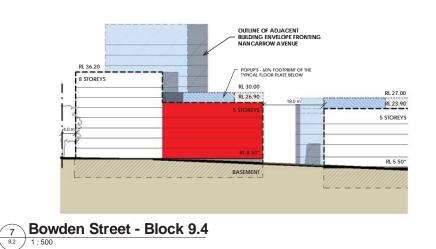


STAGE 9 - BY BLOCK				
Block	GFA*			
9.1	382 m²			
9.2	1667 m²			
9.3	8394 m²			
9.4	2247 m²			
9.5	5017 m ²			
9.6	8227 m²			
25935 m²				

BLOCK 9.4 - Area Schedule			
Block Name	Level	GFA*	
	•	•	
9.4	L1	489 m²	
9.4	L2	489 m²	
9.4	L3	489 m²	
9.4	L4	489 m²	
9.4	L5	291 m²	
		22/17 m²	



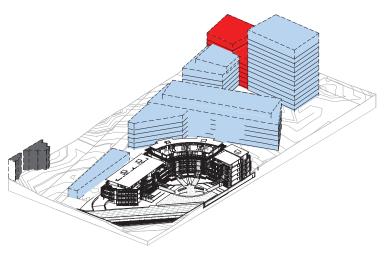

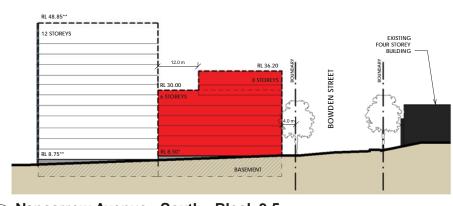


BLOCK 9.5 - Area Schedule		
Block Name	Level	GFA*
9.5	L1	685 m²
9.5	L2	685 m²
9.5	L3	685 m²
9.5	L4	685 m²
9.5	L5	685 m²
9.5	L6	685 m²
9.5	L7	454 m²
9.5	L8	454 m²
		5017 m ²

BLOCK 9.6 - Area Schedule


3D-KEY PLAN BLOCK 9.5

Nancarrow Avenue - South - Block 9.5



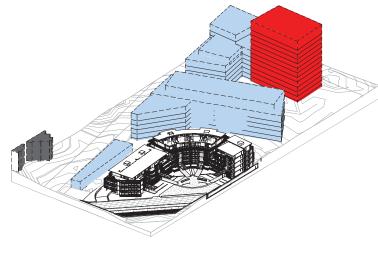


\	3D-KEY PLAN BLOCK 9.6	9	
,		9.2	Г

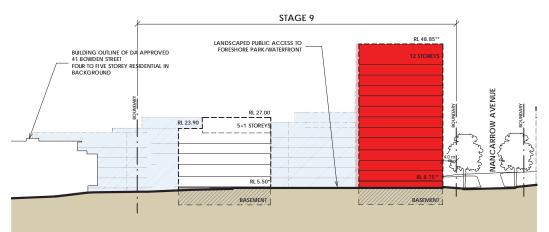



9	7. Elevation 1 - Block 9.6
9.2	1:500

PLACE DESIGN GROUP ROBERTSON+MARKS ARCHITECTS | 26

APPENDIX 2 - FLOOR SPACE CALCULATIONS:

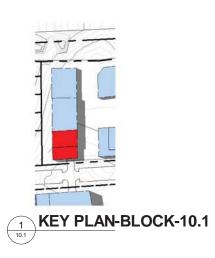

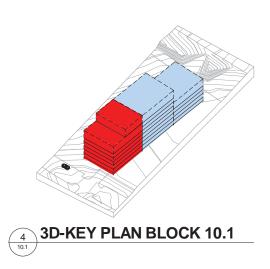


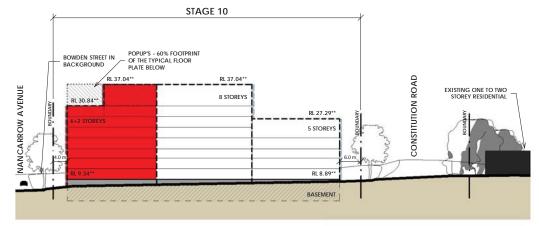



STAGE 10	STAGE 10 - BY BLOCK		
Block	GFA*		
10.1	2909 m²		
10.2	3551 m ²		
10.3	2024 m²		
,	8484 m²		

BLOCK 10.1 - Area Schedule			
Block Name	Level	GFA*	
10.1	L1	405 m ²	
10.1	L2	405 m ²	
10.1	L3	405 m ²	
10.1	L4	405 m ²	
10.1	L5	405 m ²	
10.1	L6	405 m ²	
10.1	L7	238 m²	
10.1	L8	239 m²	
		2000 m2	

7 10. Elevation 1 - Block 10.1

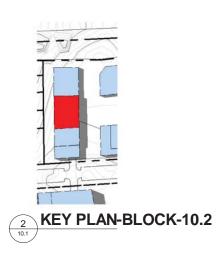

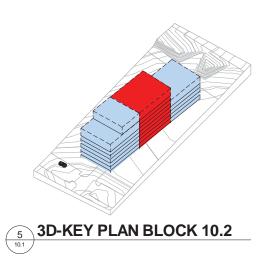


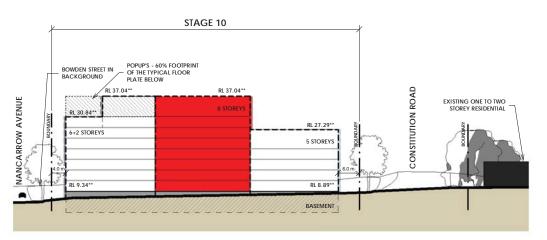



Block		T
Name	Level	GFA ³
		•
10.2	L1	444 m ²
10.2	L2	444 m²
10.2	L3	444 m²
10.2	L4	444 m²
10.2	L5	444 m²
10.2	L6	444 m²
10.2	L7	444 m²
10.2	L8	444 m²
	•	3551 m ²

BLOCK 10.3 - Area Schedule

8 10. Elevation 1 - Block 10.2

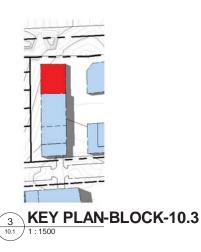

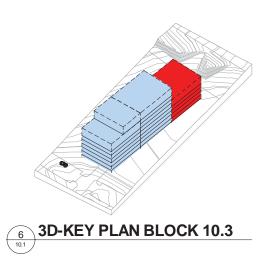

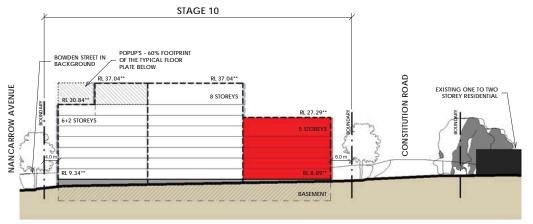



BOUND	10.3	L1	405 m ²
8	10.3	L2	405 m ²
	10.3	L3	405 m²
	10.3	L4	405 m²
5	10.3	L5	405 m²
			2024 m²

9 10. Elevation 1 - Block 10.3


3.

APPENDIX 3 - BUILDING ENVELOPE LONG SECTIONS

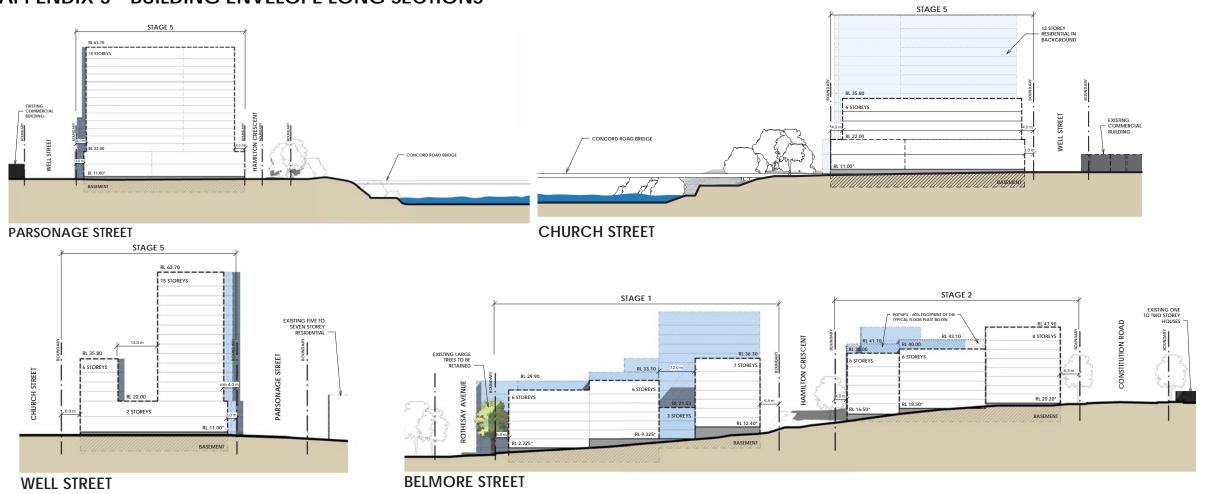

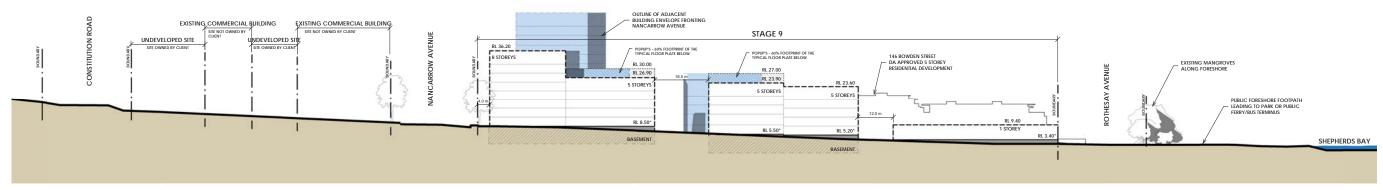


BOWDEN STREET

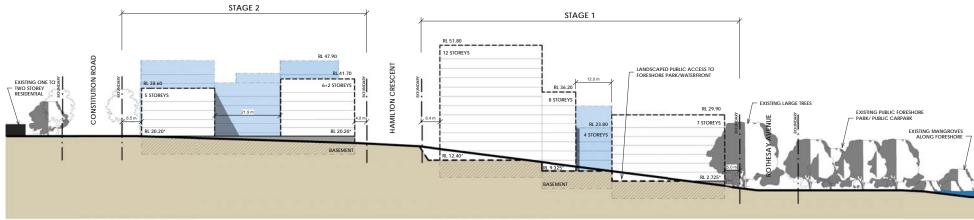


STAGE 2 AND 1 - WEST VIEW

Note: Including indicative storeys for the purpose of calculating height only


APPENDIX 3 - BUILDING ENVELOPE LONG SECTIONS

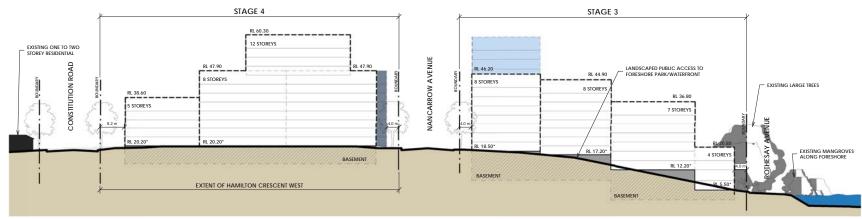


HAMILTON CRESCENT WEST - EAST VIEW

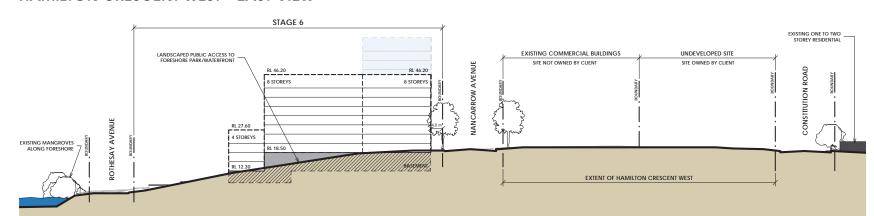


HAMILTON CRESCENT WEST - WEST VIEW

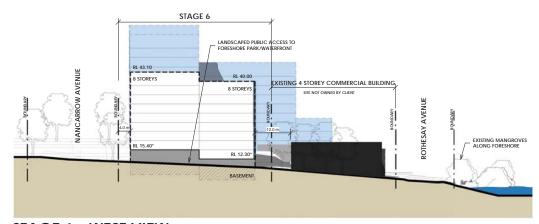

STAGE 6 - WEST VIEW

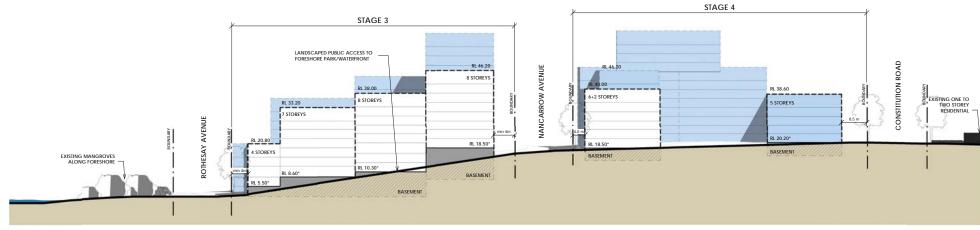


STAGE 3 AND 4 - WEST VIEW

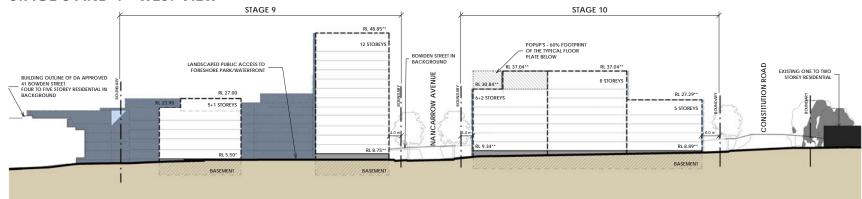


STAGE 9 AND 10 - EAST preferred project report Note: Including indicative storeys for the purpose of calculating height only


APPENDIX 3 - BUILDING ENVELOPE LONG SECTIONS

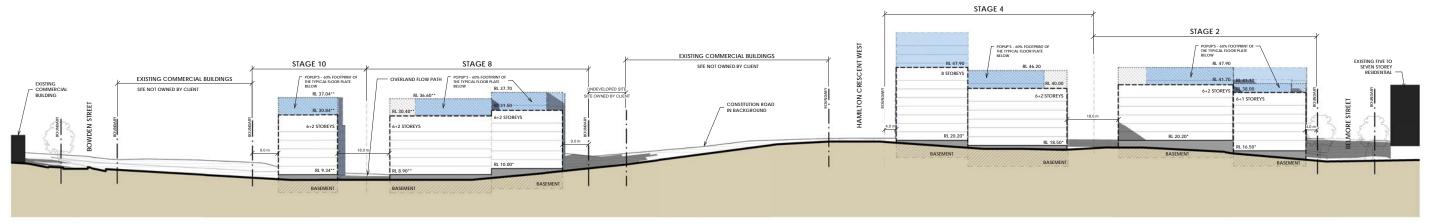

NANCARROW AVENUE NORTH

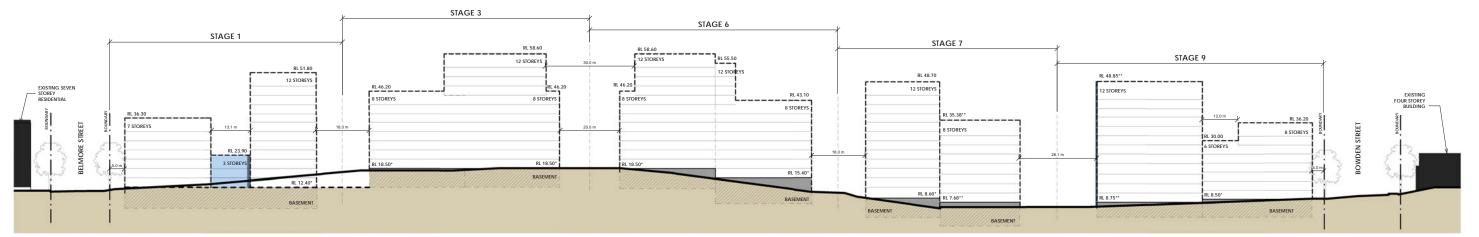


NANCARROW AVENUE - SOUTH

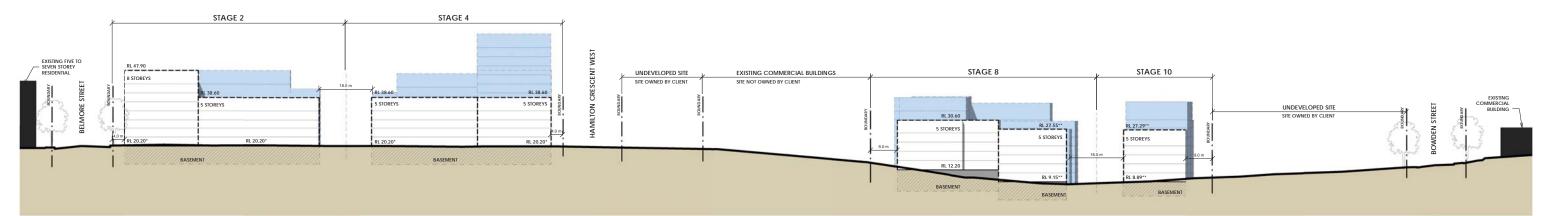


CONSTITUTION ROAD

Note: Including indicative storeys for the purpose of calculating height only


APPENDIX 3 - BUILDING ENVELOPE LONG SECTIONS

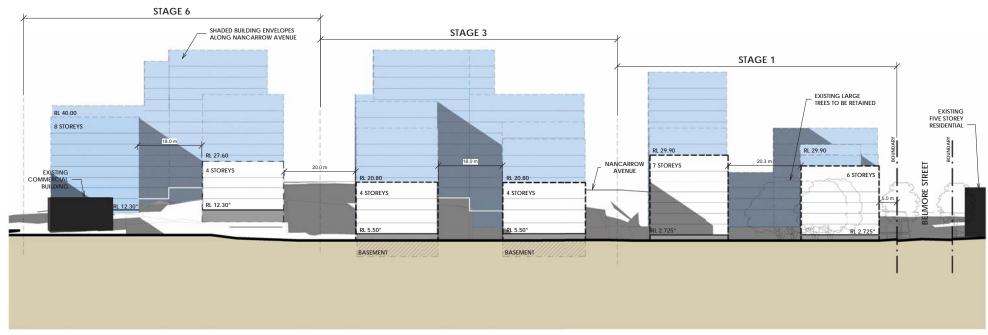

ROTHESAY AVENUE

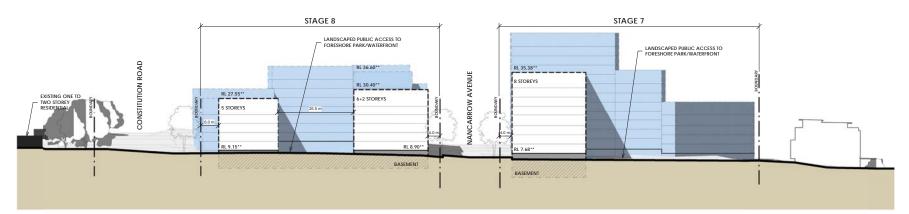

STAGE 7 AND 8 - WEST VIEW

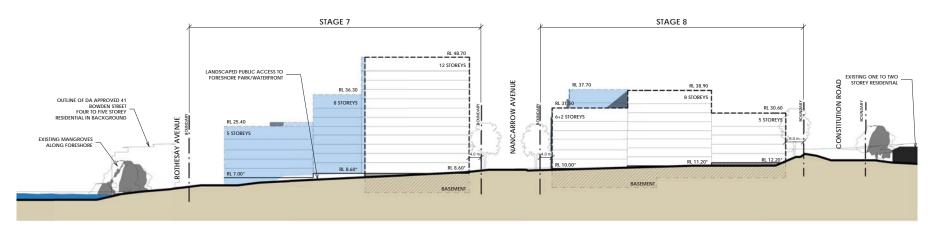

STAGE 7 & 8 EAST VIEW


Note: Including indicative storeys for the purpose of calculating height only

PLACE DESIGN GROUP

APPENDIX 4 - ARTIST IMPRESSIONS



Artist Impression 1 - Aerial view looking south across Parramatta River to Rhodes & Olympic Park beyond.

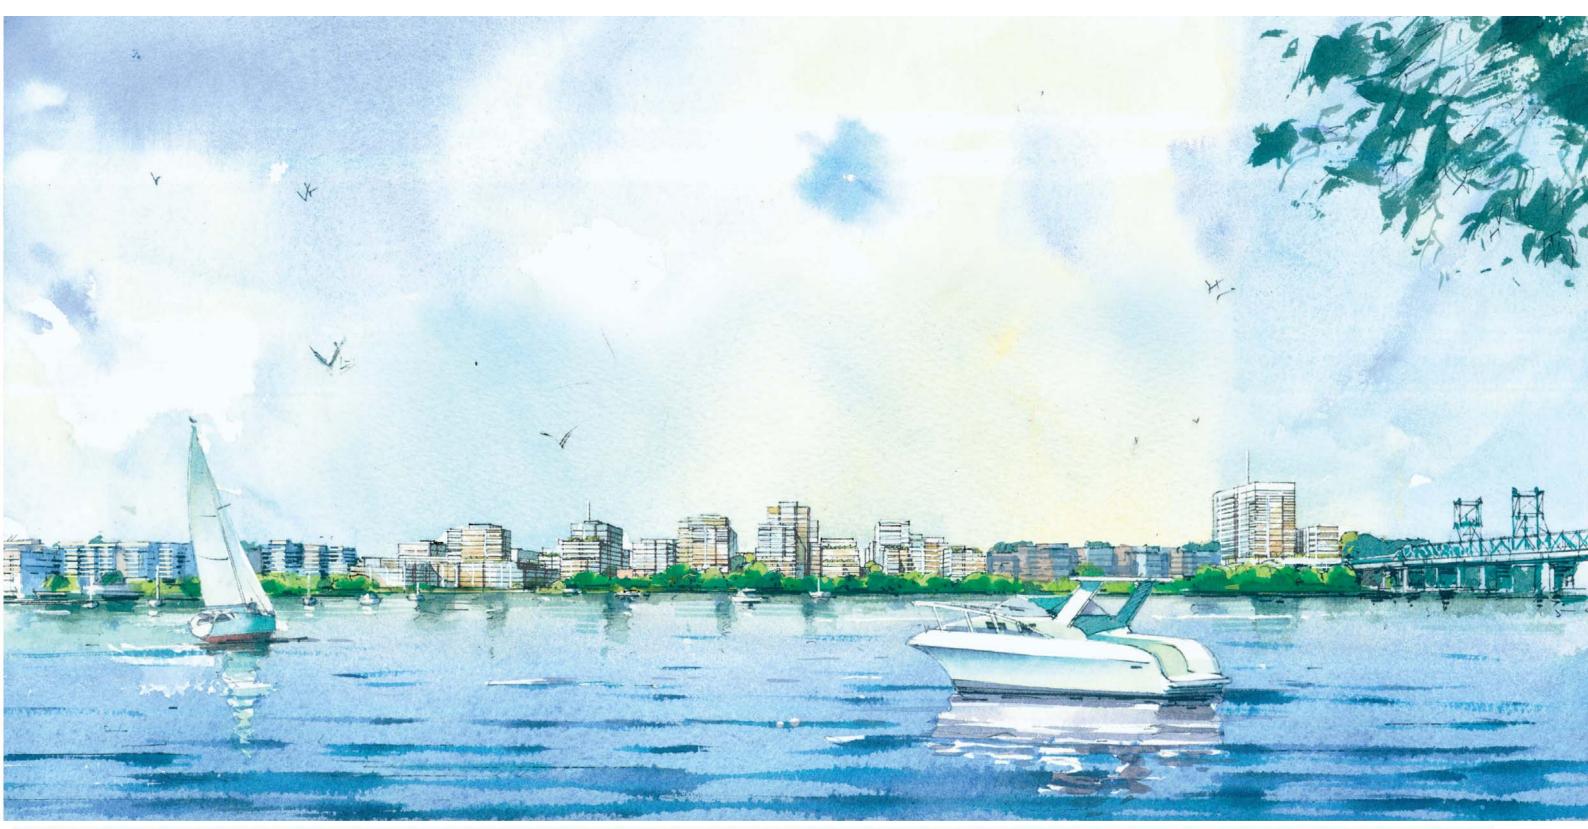

Artist Impression 2 - Pedestrian view looking across Parramatta River to Shepherds Bay.



Artist Impression 3 - View looking down Belmore Street to Parramatta River and Rhodes beyond.



Artist Impression 4 - Pedestrian view looking down Bowden Street to Parramatta River & Rhodes development beyond.



Artist Impression 5 - Pedestrian view looking down Central public pedestrian walkway to Foreshore Plaza and Parramatta River with Rhodes development beyond.



Artist Impression 6 - Pedestrian view looking down Constitution Road at the junction intersecting Bowden Street.



Artist Impression 7 - View looking down Nancarrow Avenue towards Belmore Street.


SHEPHERDS BAY URBAN RENEWAL




Artist Impression 8 - View looking at the Foreshore Plaza along Rothesay Avenue with Concord Road Bridge beyond...

APPENDIX 5 - BUILDING SEPARATION PLAN



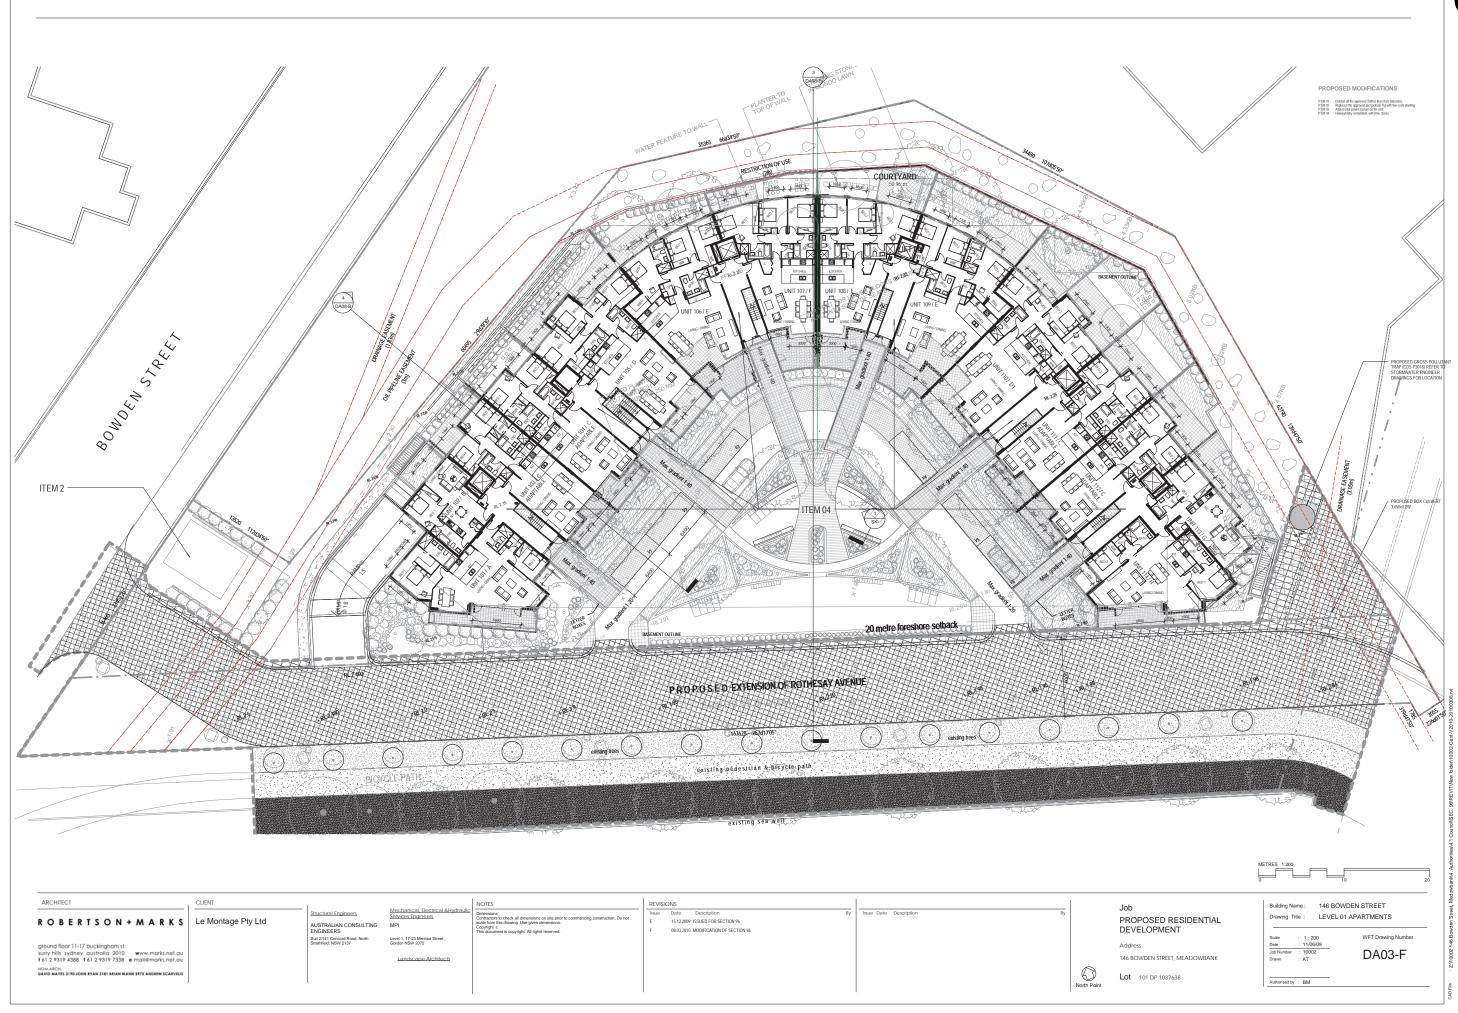

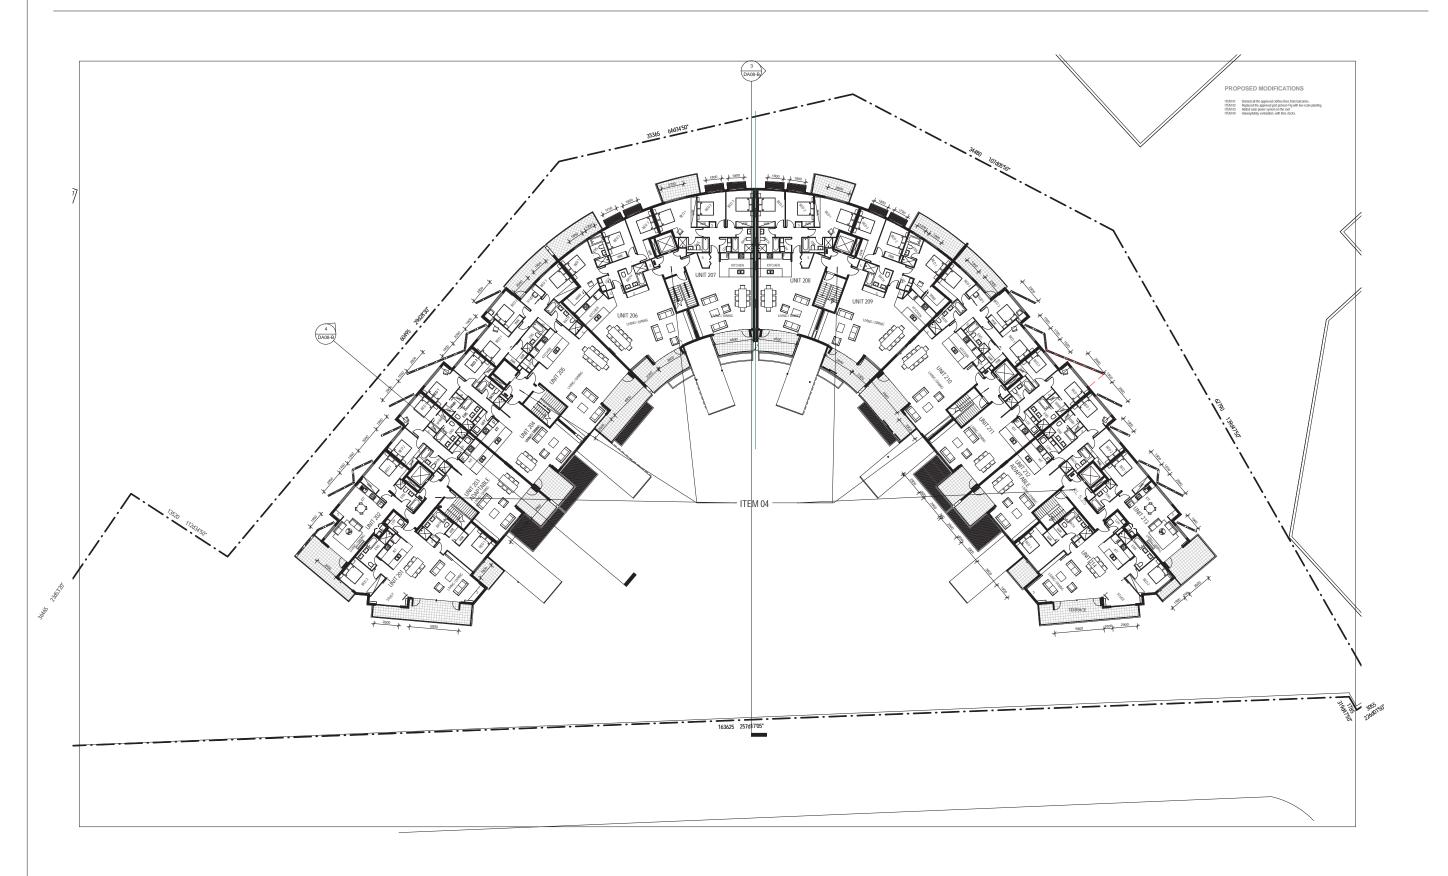

ARKS Le N
w.marks.net.au 1@marks.net.au

Le Montage Pty Ltd

Mechanical Electrical & Hye
Services Engineers

N CONSULTING
MPI
Socrat Road, North
Level 1, 17.23 Morrino Street ,
Gordon NSW 2072

NOTES

Dimensions

Cartescates to check all dimensions on site prior to commencing construction. Do not a construction to check all dimensions on site prior to commencing construction. Do not construct the disease of the dimensions.

This document is copyright. All rights reserved.


Job
PROPOSED RESIDENTIAL
DEVELOPMENT
Address

Address
146 BOWDEN STREET, MEADOWBANK

LOT 101 DP 1037638

Building Name : 146 BOWDEN STREET
Drawing Title : LEVEL 02 APARTMENTS

e : 1:200 WFT Drawing Number : 1106/09 DA04-E

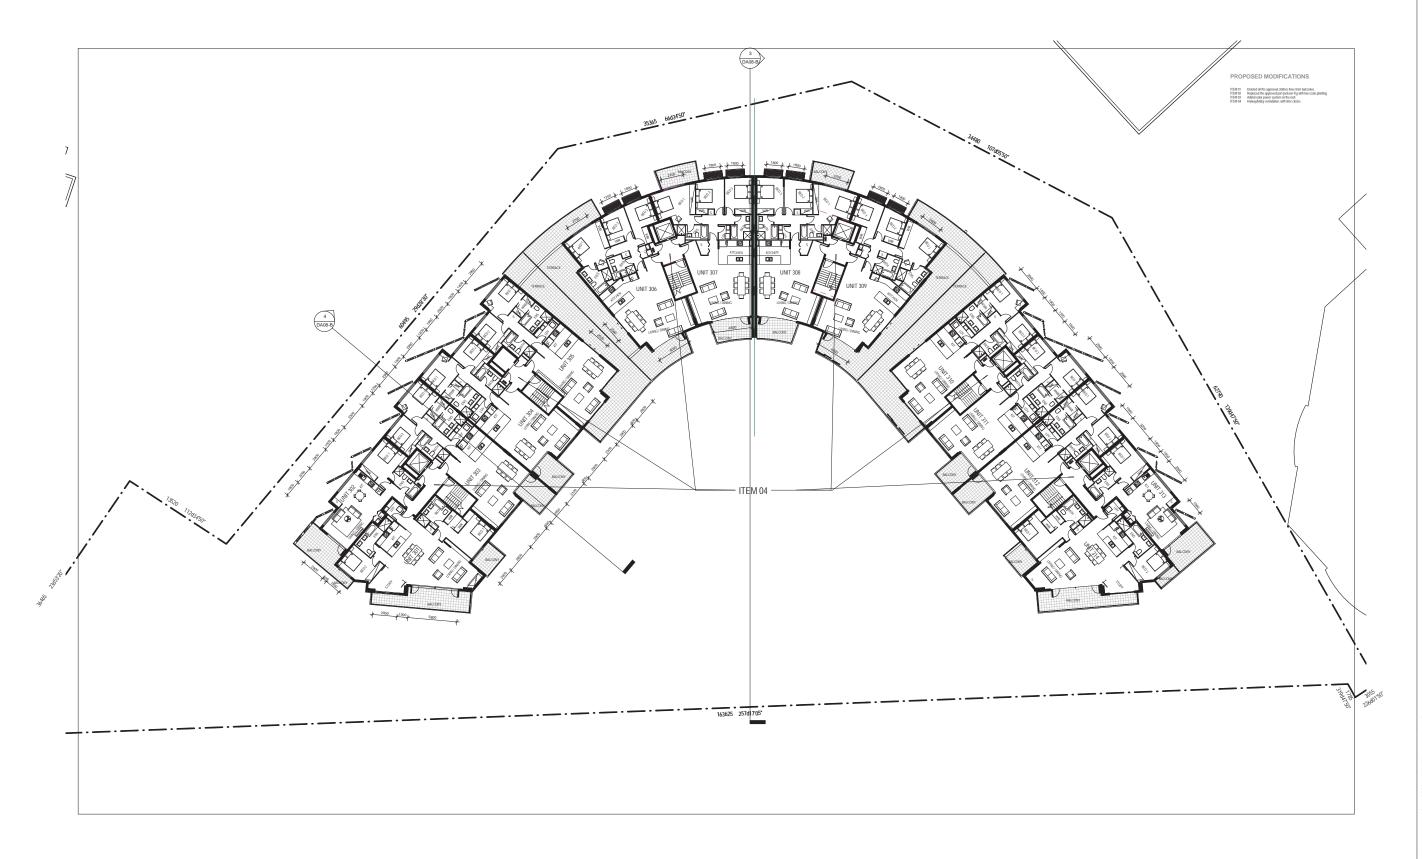

ARCHITECT
R O B E R T S O N + M A R K S
ground floor 11-17 buckingham st surry hills sydney australia 2010 www.marks.net.au t 61 2 9319 4388 t 61 2 9319 7338 e mail@marks.net.au
NOM, ARCH. DAVID MAYES 3190 JOHN RYAN 3181 BEIAN MANN 5975 ANDREW SCARVEUS

	OLILIVI
SON+MARKS	Le Montage Pty Ltd
kingham st	

ural Engineers	Mechanical, Elect Services Engineers
RALIAN CONSULTING NEERS	MPI
41 Concord Road, North eld, NSW 2137	Level 1, 17-23 Merriwa Gordon NSW 2072
	Landscape Are

	NOTES
nical, Electrical & Hydraulic s Engineers	Dimensions Contractors to check all dimensions on site prior to commencing construction. Do not scale from this drawing. Use given dimensions. Copyright c This document is copyright. All rights reserved.
7-23 Merriwa Street , SW 2072	

Issue	Date	Description
D	15.12.2009	ISSUED FOR SECTION 96
E	08.03.2010	MODIFICATION OF SECTION 96


ssue Date	Description	Ву

PROPOSED RESIDENTIAL DEVELOPMENT	


Address	
146 BOWDEN STREET, MEADOWBANK	
Lat	

Building Name :	146 BOWDEN STREE
Drawing Title :	LEVEL 03 APARTMEN


ale	: 1:200	WFT Drawing Number
ite	: 11/06/09	
b Number	: 10002	DA05-E
awn	: AT	DA03-L

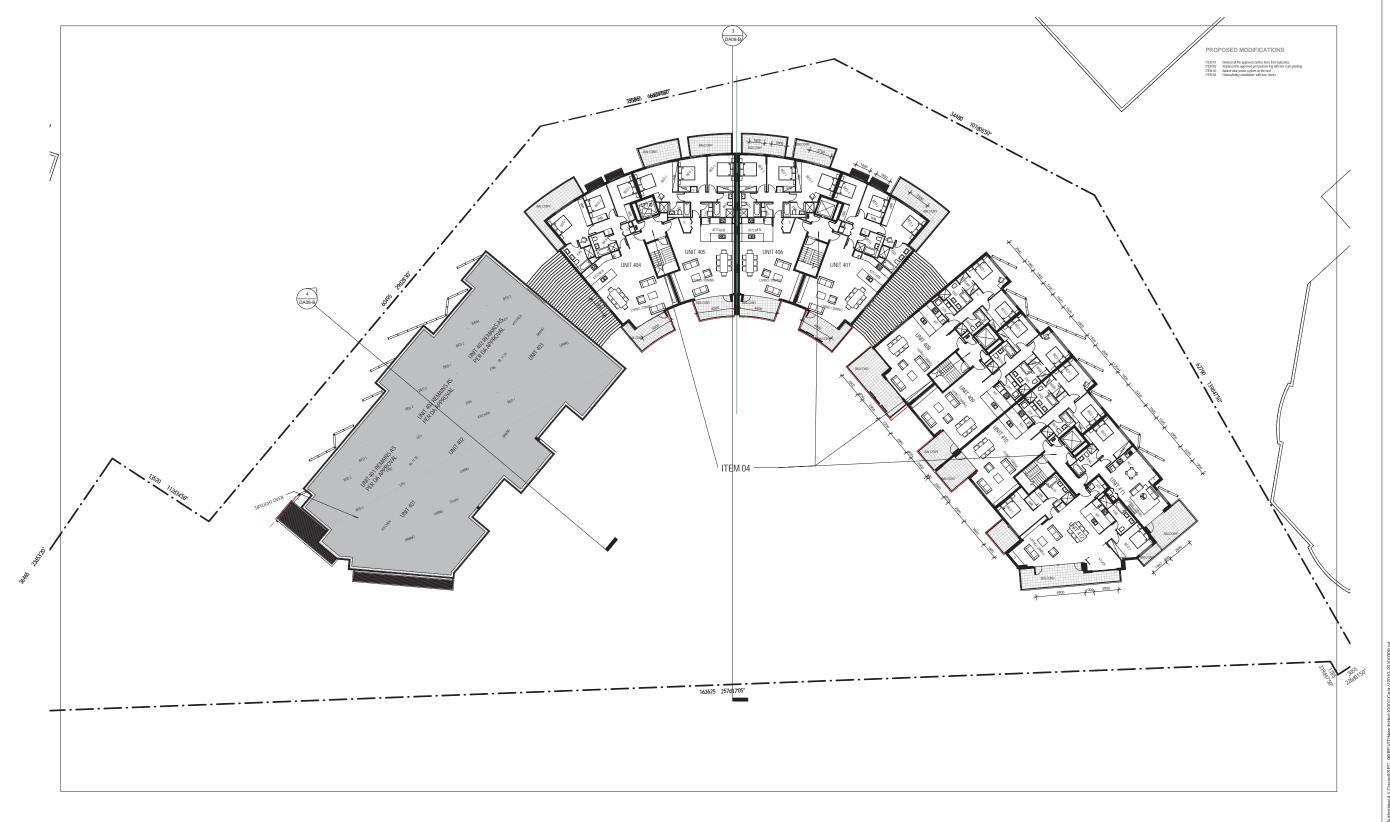


ARCHITECT	CLIENT			Lucra	Language	1	1		
ARCHIECT	CLEW	Structural Engineers	Mechanical, Electrical & Hydraulio	NOTES Dimensions	REVISIONS Issue Date Description Bry	Issue Date Description	By	Job	Building Name: 146 BOWDEN STREET
ROBERTSON+MARKS	Le Montage Pty Ltd	AUSTRALIAN CONSULTING	Services Engineers	Contractors to check all dimensions on site prior to commencing construction. Do not scale from this drawing. Use given dimensions.	D 15.12.2009 ISSUED FOR SECTION 96	·		PROPOSED RESIDENTIAL	Drawing Title : LEVEL 04 APARTMENTS
	,	ENGINEERS	IVIFI	Copyright c This document is copyright. All rights reserved.	E 08.03.2010 MODIFICATION OF SECTION 96			DEVELOPMENT	
arrived floor 33, 17 hypelianham st		Suit 2/141 Concord Road, North Strathfield, NSW 2137	Level 1, 17-23 Merriwa Street , Gordon NSW 2072					Address	Scale : 1 : 200 WFT Drawing Number Date : 11/06/09
ground floor 11-17 buckingham st surry hills sydney australia 2010 www.marks.net.au									Job Number : 10002 Drawn : AT DA06-E
t 61 2 9319 4388 t 61 2 9319 7338 e mail@marks.net.au			Landscape Architects					146 BOWDEN STREET, MEADOWBANK	Drawn : AT
NOM.ARCH. DAVID MAYES 3190 JOHN RYAN 3181 BRIAN MANN 5975 ANDREW SCARVEUS							8	Lot 101 DP 1037638	
							North Point	LOT 101 DP 1037638	Authorised by : BM
							1		

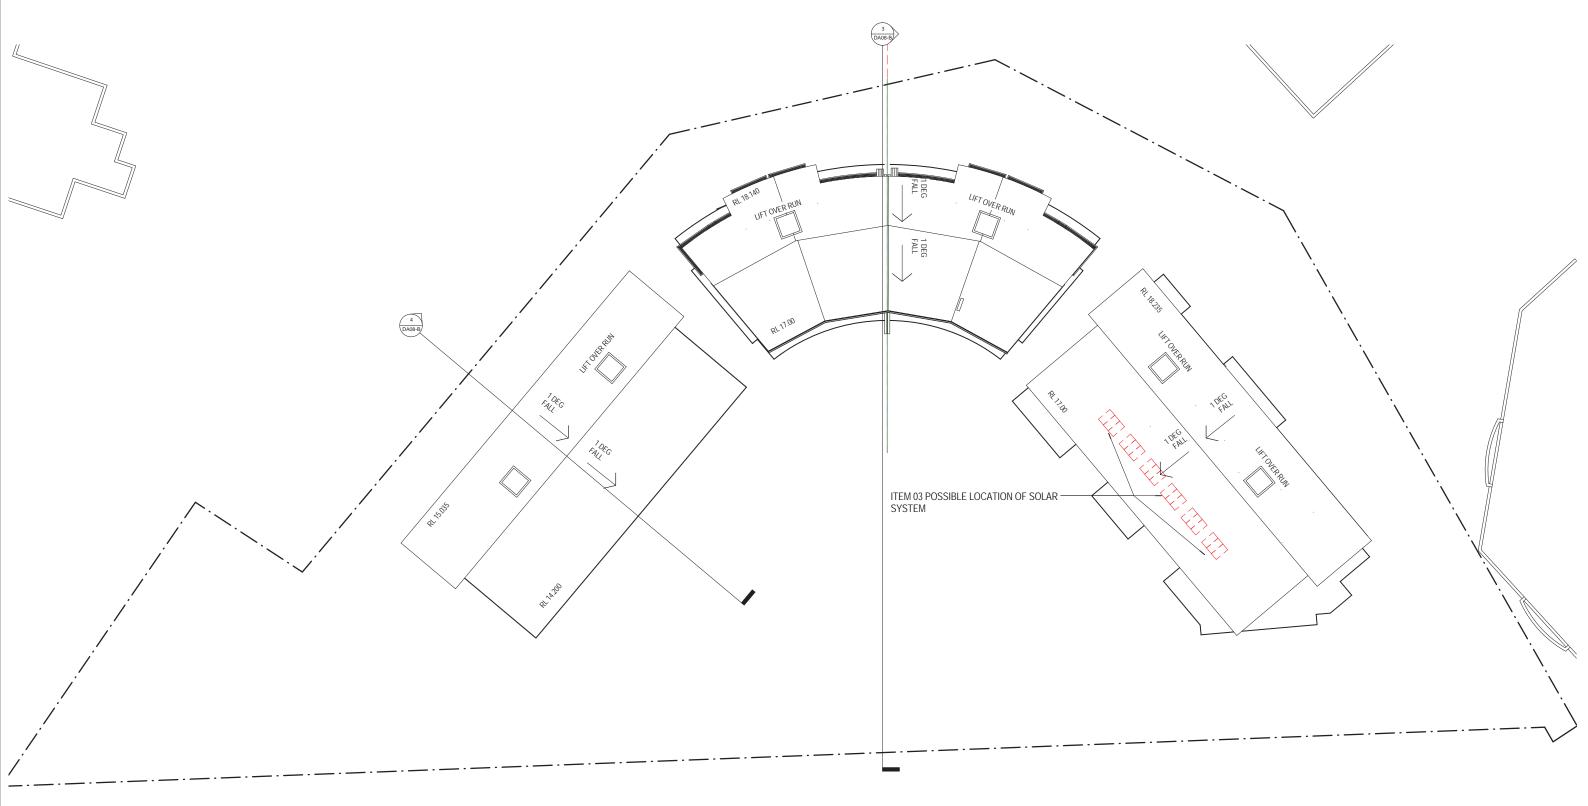

ARCHITECT	CLIENT	1		NOTES	REVISIONS			Job	Building Name: 146 BOWDEN STREET
ROBERTSON+MARKS	Le Montage Pty Ltd	Structural Engineers AUSTRALIAN CONSULTING ENGINEERS	Mechanical, Electrical & Hydraulic Services Engineers MPI	Dimensions Contractors to check all dimensions on site prior to commencing construction. Do not scale from this drawing. Use given dimensions. Copyright c This document is copyright. All rights reserved.	Issue Date Description By C 25.03.2010 MODIFICATION OF SECTION 96	Issue Date Description	Ву	PROPOSED RESIDENTIAL DEVELOPMENT	Drawing Title : ROOP PLAN
ground floor 11-17 buckingham st surry hills sydney australia 2010 www.marks.net.au t 61 2 9319 4388 f 61 2 9319 7338 e mail@marks.net.au		Suit 2/141 Concord Road, North Strathfield, NSW 2137	Level 1, 17-23 Merriwa Street , Gordon NSW 2072 Landscape Architects					Address 146 BOWDEN STREET, MEADOWBANK	Scale
NOM.ARCH. DAVID MAYES 3190 JOHN RYAN 3181 BRIAN MANN 5975 ANDREW SCARVEUS							North Point	Lot 101 DP 1037638	Authorised by : Approver

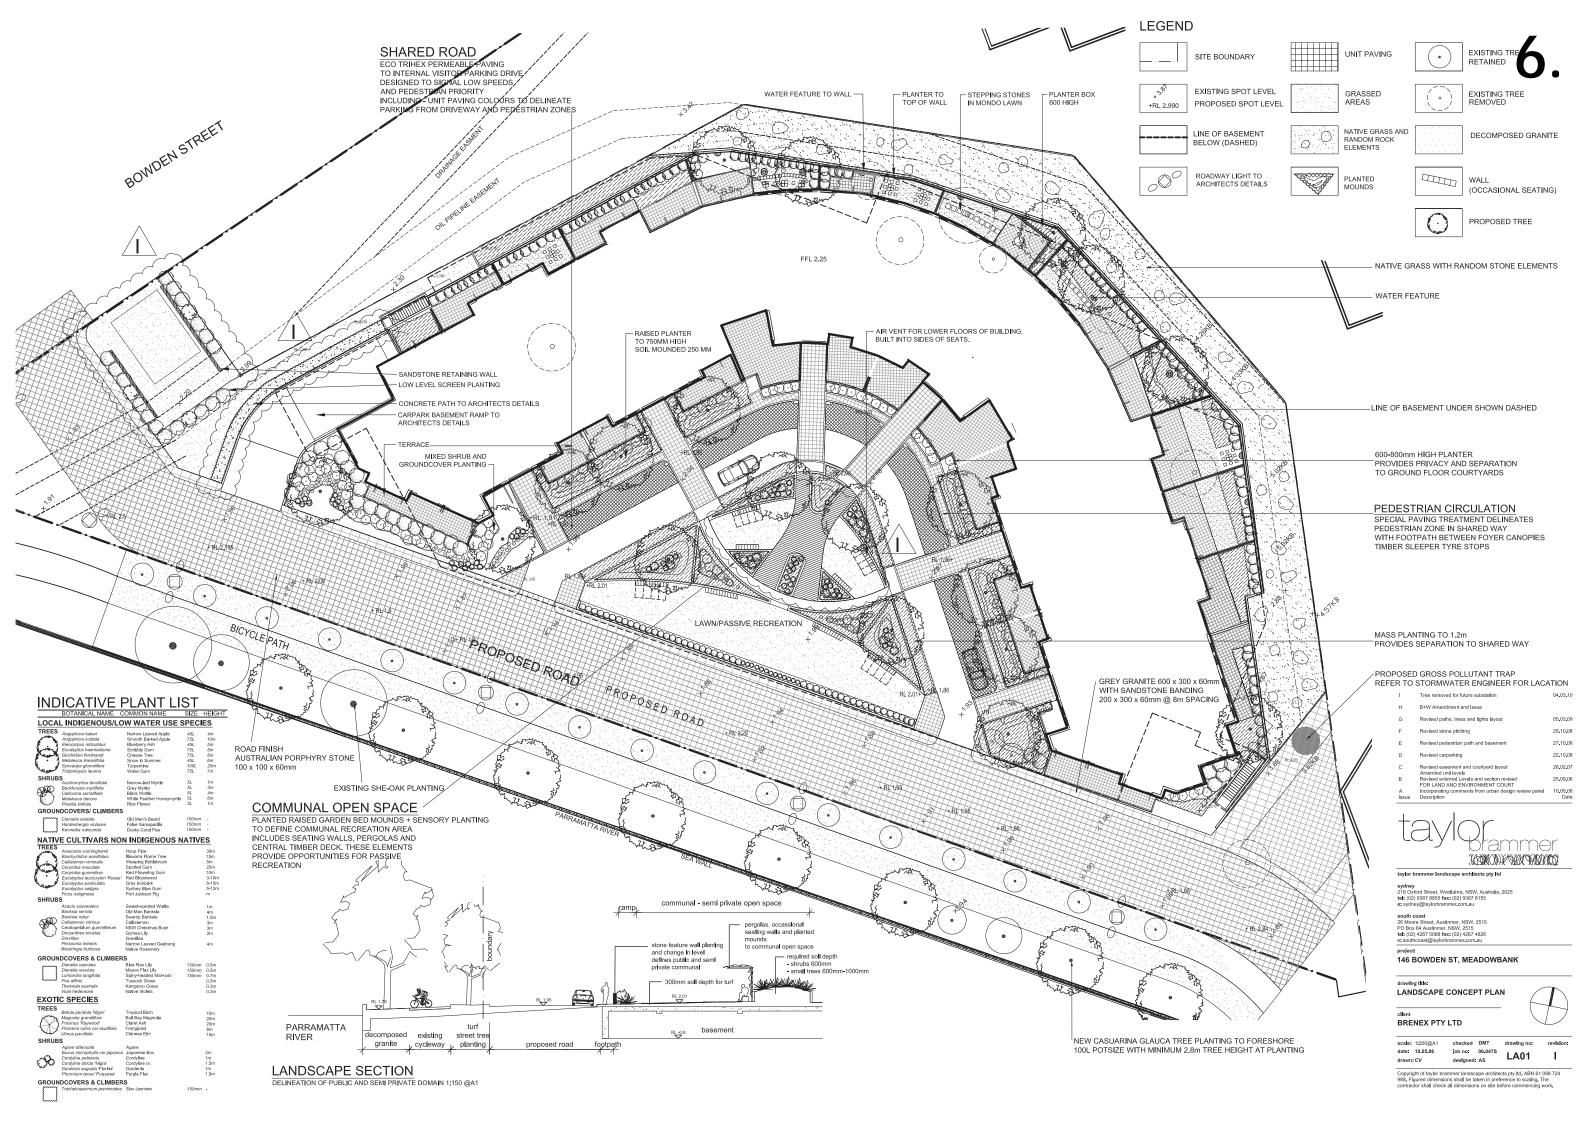


APPENDIX 7 - IMPACT ON ISOLATED SITES:

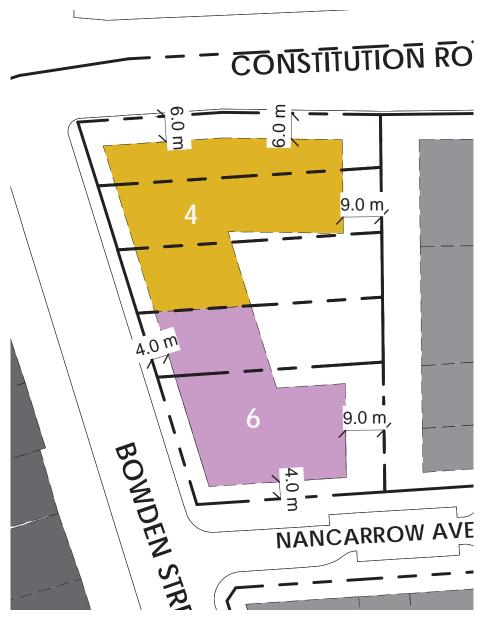

ISOLATED SITE 1:

1B UNITS	2B UNITS	3B UNITS	TOTAL
12	87	17	116

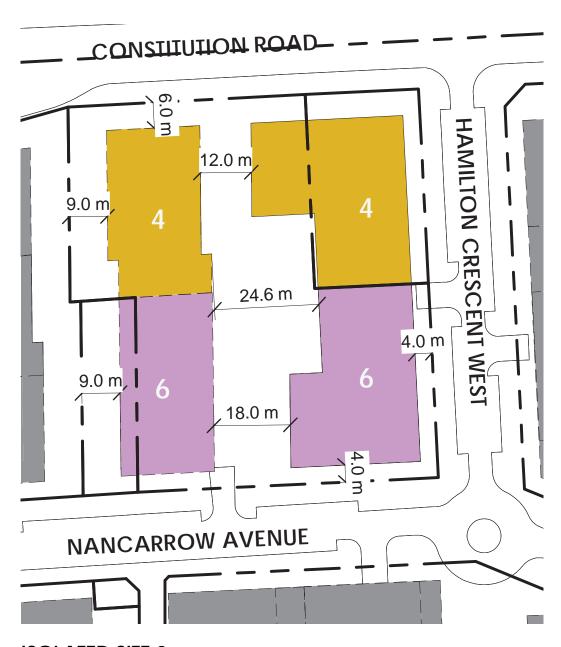


ISOLATED SITE 2:

1B UNITS	2B UNITS	3B UNITS	TOTAL
17	127	25	169

APPENDIX 8 - OPEN SPACE:



APPENDIX 9 - SUN ACCESS TO OPEN SPACE:

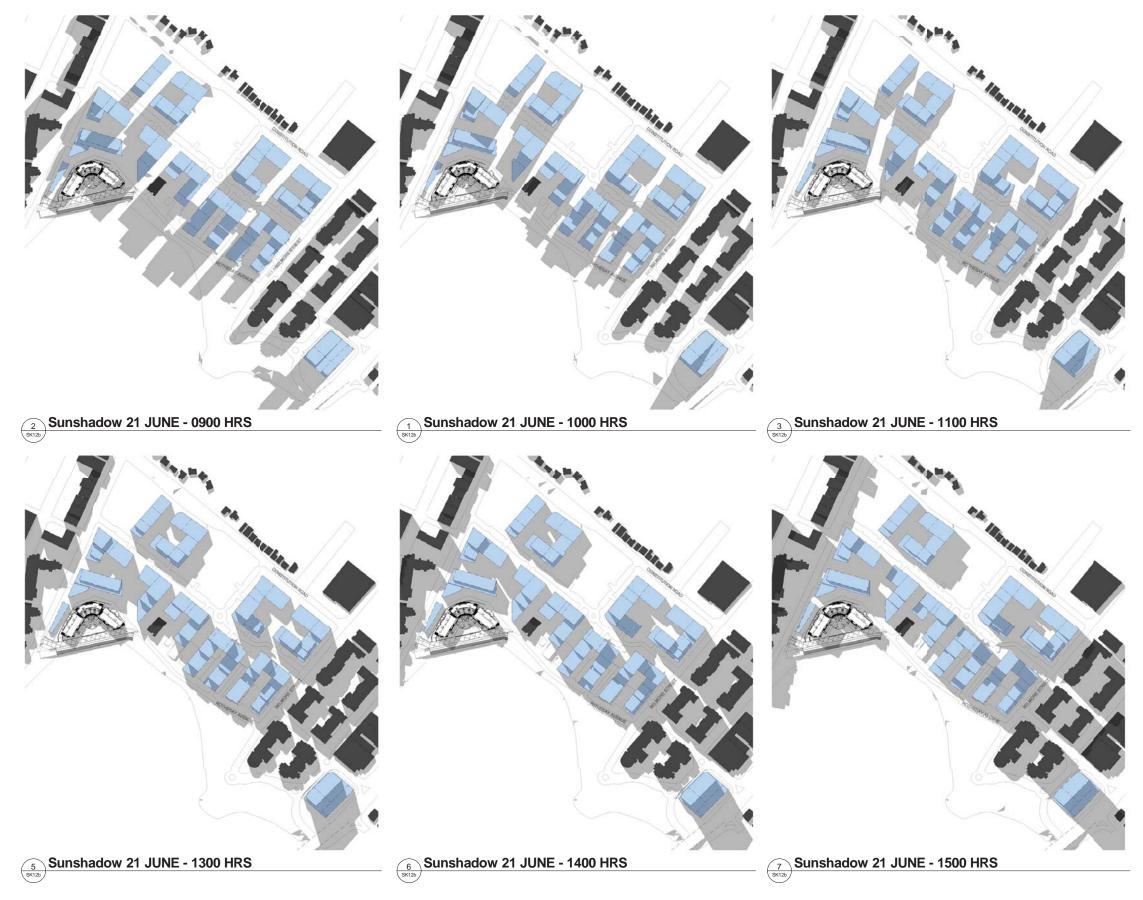



TIME	PUBLIC OPEN	SUN LIT AREA	%
	SPACE (sqm)	(sqm)	
900	18422	8934	48.49
1000	18422	7800	42.34
1100	18422	6090	33.06
1200	18422	5350	29.04
1300	18422	4965	26.95
1400	18422	4345	23.58
1500	18422	3535	19.19

TIME	COMMUNAL	SUN LIT	%
	OPEN SPACE	AREA (sqm)	
	(sqm)		
900	5052	656	12.98
1000	5052	490	9.70
1100	5052	510	10.10
1200	5052	600	11.88
1300	5052	460	9.11
1400	5052	400	7.92
1500	5052	270	5.34

preferred project report JULY 2012 | REV 2 PLACE DESIGN GROUP R O B E R T S O N + M A R K S ARCHITECTS | 49

SHEPHERDS BAY URBAN RENEWAL

10.

APPENDIX 10 - STORMWATER EASEMENT:

APPENDIX 10 - STORMWATER EASEMENT:



SHEPHERDS BAY, MEADOWBANK TRUNK DRAINAGE DESIGN CONCEPT CIVIL ENGINEERING DESIGN


DRAWING SCHEDULE

600283-0001 COVER SHEET & DRAWING LIST

TRUNK DRAINAGE PLAN

600283-0003 TRUNK DRAINAGE LONGITUDINAL SECTION

600283-0004 STORMWATER PIT DETAILS

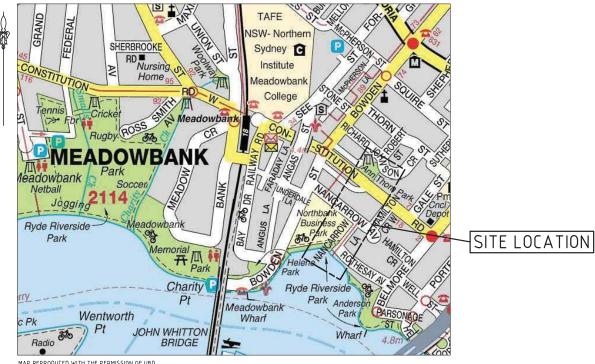

LOCALITY PLAN

16/12/2011 PRELIMINARY






	DP
*	Checked CE
*	Designed JM
Quality Endorsed Company	Verified G J
AS 9001 Lie. 5960 Standards Australia	Approved

Date 16/12/2011	Client HOLDMARK PROPERTY	GROUP
16/12/2011 Date	SHEPHERDS BAY, MEADOWBANK TRUNK DRAINAGE DESIGN	NO T
16/12/2011 Date		Date 14/12/


COVER SHEET & DRAWING LIST

NOT FOR CONSTRUCTION 600283-0001

50 60 70 80 90 100 110 120 130 140 150mm ON A1 ORIGINAL

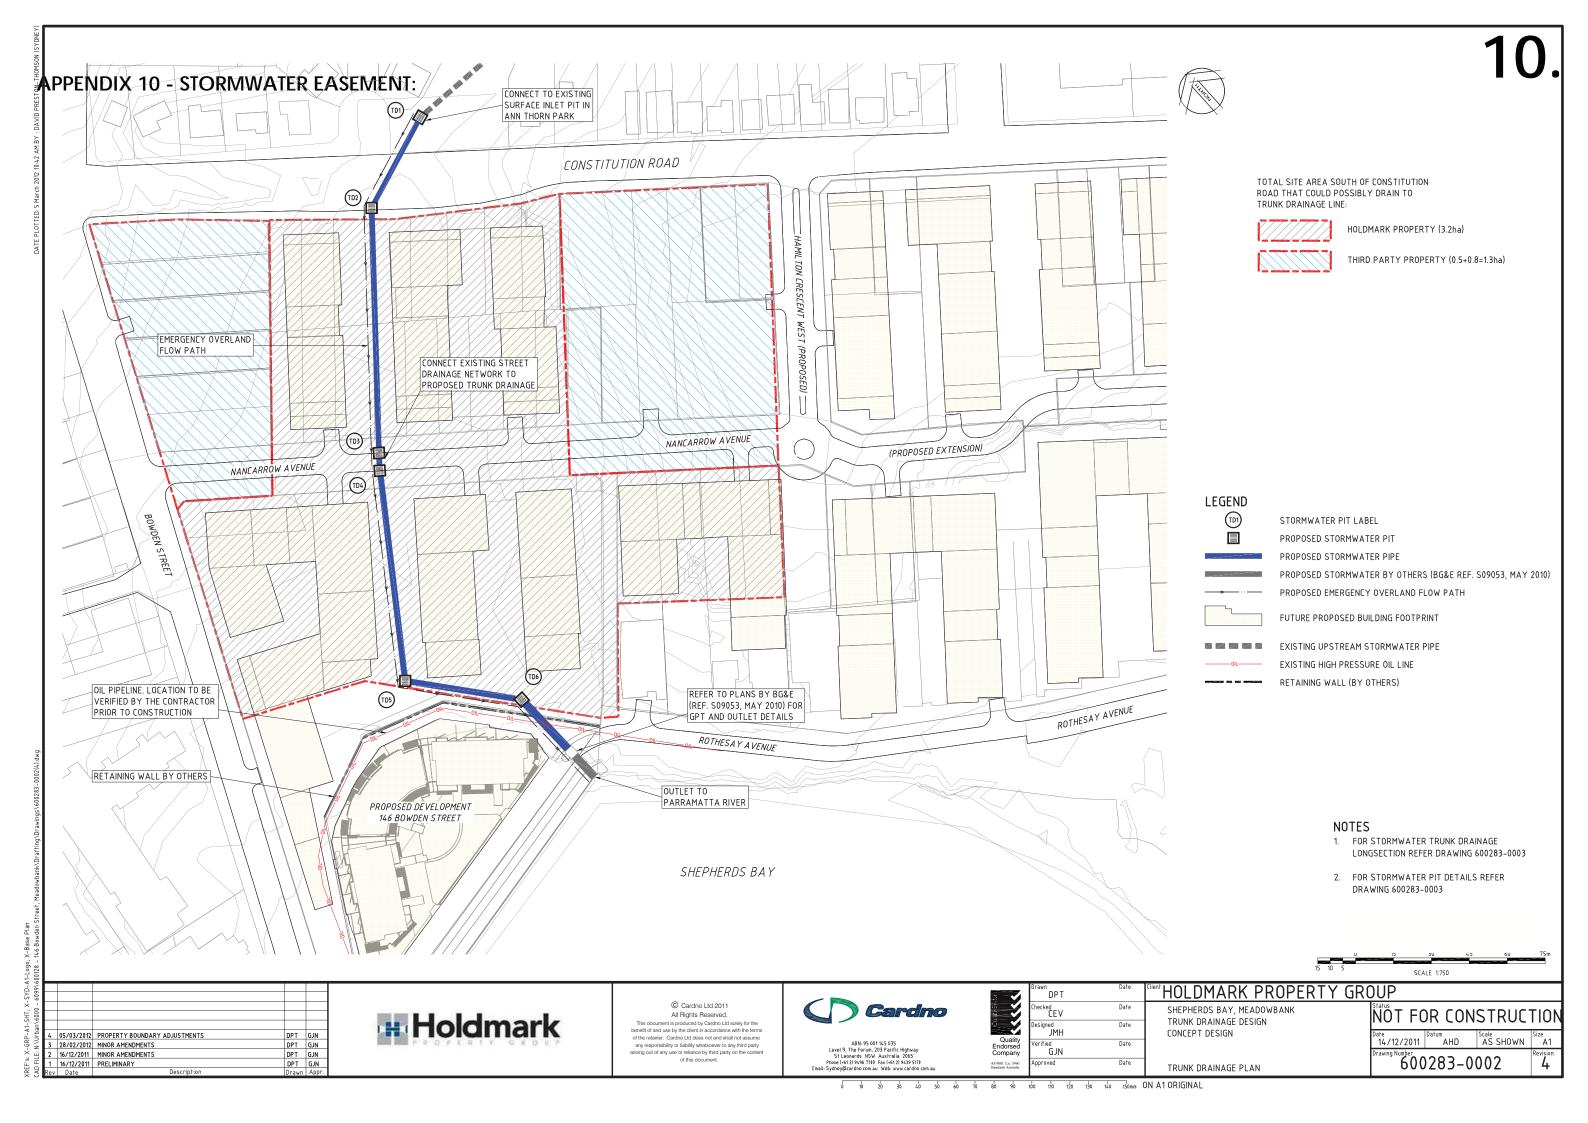

APPENDIX 10 - STORMWATER EASEMENT:

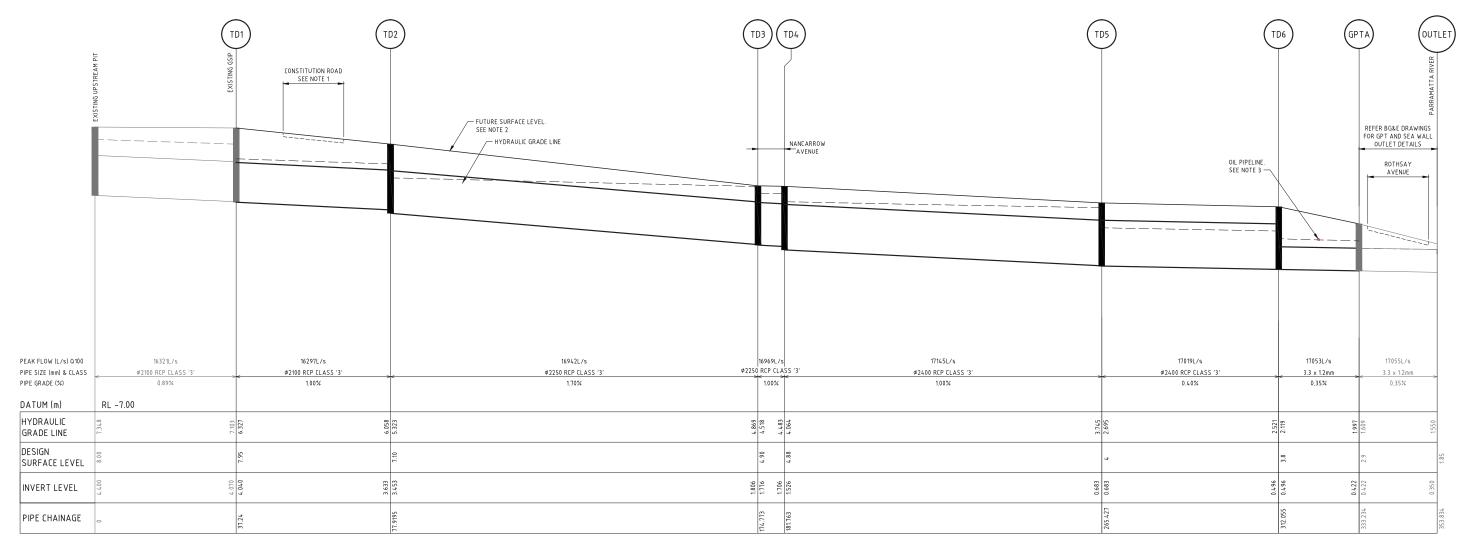



LONGITUDINAL SECTION ALONG TRUNK DRAINAGE LINE
- 100 YR ARI CRITICAL STORM EVENT

SCALE 1:500 (HORI) 1:100 (VERT)

NOTES

- FUTURE LEVELS OF CONSTITUTION ROAD SUBJECT TO DETAIL DESIGN (BY OTHERS) OF REVISED ROAD ALIGNMENT FOLLOWING CONSTRUCTION OF TRUNK DRAINAGE NETWORK
- 2. FUTURE SURFACE LEVELS BETWEEN PROPOSED BUIDINGS ARE INDICATIVE AND SUBJECT TO FURTHER DESIGN DEVELOPMENT
- 3. OIL PIPELINE DEPTH AND LOCATION INDICATIVE ONLY AND TO BE VERIFIED BY THE CONTRACTOR PRIOR TO CONSTRUCTION

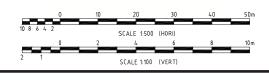

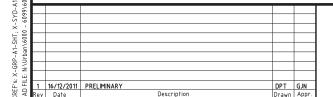



© Cardno Ltd 2011

All Rights Reserved.

This document is produced by Cardno Ltd solely for the benefit of and use by the client in accordance with the terms of the refainer. Cardno Ltd does not and shall not assume any responsibility or liability whatsoever to any third party arising out of any use or refaince by third party on the content of this document.



	CI
· · ·	De
Quality Endorsed Company	٧
AS 9001 Lic. 5960 Standards Australia	Α

.	DI I	107 127 2011
X	Checked CEV	16/12/2011
Ž	Designed JMH	Date 16/12/2011
ility sed any	Verified GJN	Date 16/12/2011
5960	Approved	Date

SHEPHERDS BAY, MEADOWBANK
TRUNK DRAINAGE DESIGN
CONCEPT DESIGN
TRUNK DRAINAGE LONGITUDINAL SECTION


Status NOT FOR CONSTRUCTION

Date 14/12/2011 Datum AHD AS SHOWN A1


Drawing Number 600283-0003 Revision 1





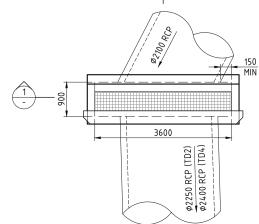



PIT DETAIL - TD2 & TD4 SCALE 1:50

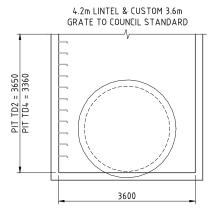


SECTION


SCALE 1:50

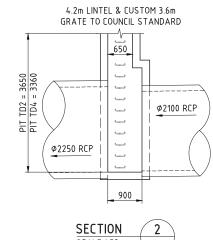


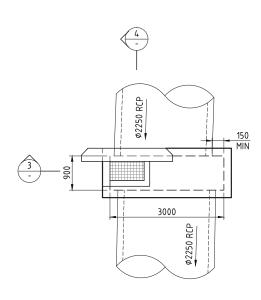


PIT DETAIL - TD3 SCALE 1:50

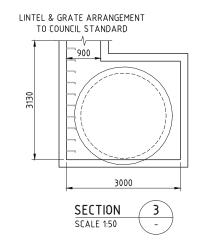


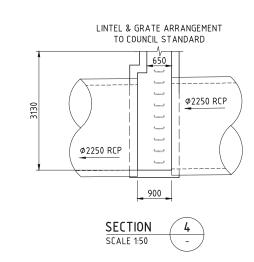


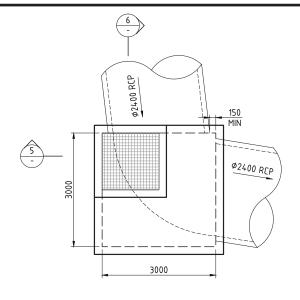


PIT DETAIL - TD5 SCALE 1:50

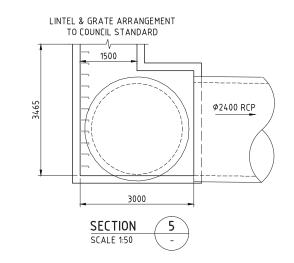


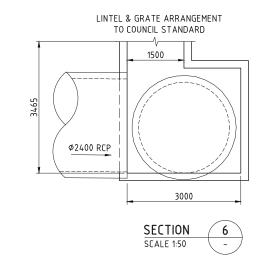


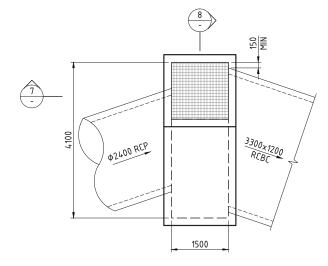

PIT DETAIL - TD6 SCALE 1:50

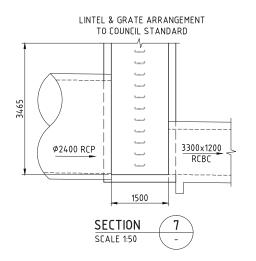

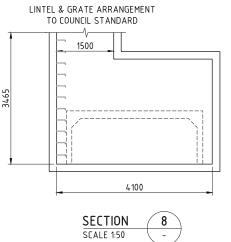

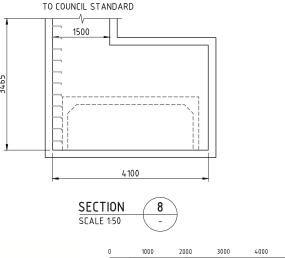





© Cardno Ltd 2011 All Rights Reserved.

This document is produced by Cardno Ltd solely for the benefit of and use by the client in accordance with the terms of the retainer. Cardno Ltd does not and shall not assume any responsibility or liability whatsoever to any third party arising out of any use or reliance by third party on the content of this document.



ABN: 95 001 145 035
910 Pacific Highway, Gordon, NSW Australia 207
Phone (+612) 9496 7700 Fax (+612) 9499 3902
Email: Sydney@cardno.com.au Web: www.cardno.com

	Dra
×	Che
	Des
Quality Endorsed Company	۷e

	DPT	16/12/2
	Checked CEV	16/12/2
	Designed JMH	Date 16/12/2
ity ed ny	Verified GJN	Date 16/12/2
160	Approved	Date

"HOLDMARK PROPERTY GROUP SHEPHERDS BAY, MEADOWBANK


TRUNK DRAINAGE DESIGN CONCEPT DESIGN


STORMWATER PIT DETAILS


NÖT FOR CONSTRUCTION 600283-0004


11.


APPENDIX 11 - SHADOW IMPACT ON 146 BOWDEN STREET:

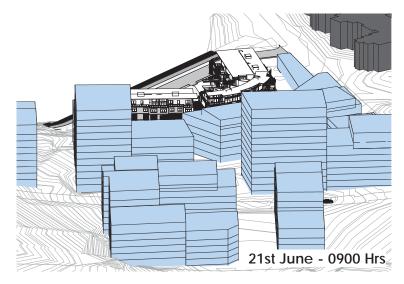


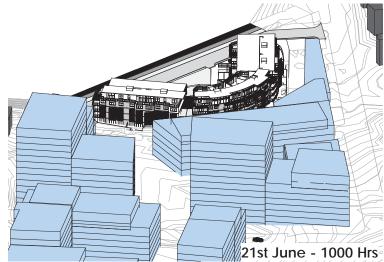


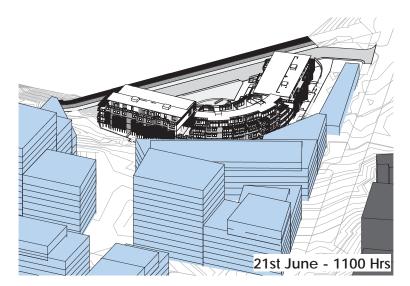


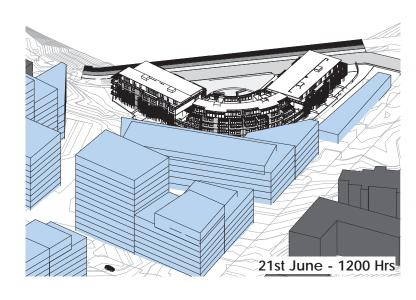

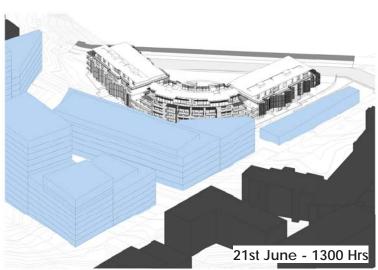

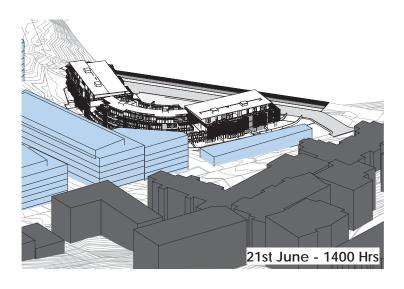

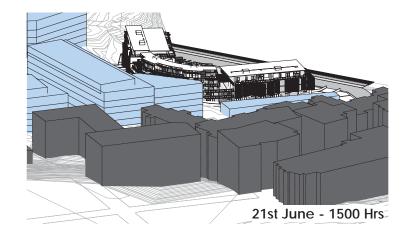

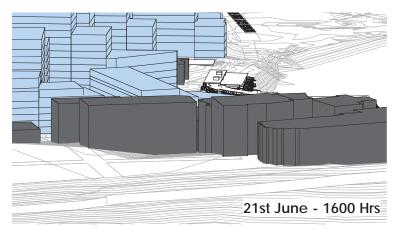

preferred project report JULY 2012 | REV 2 PLACE DESIGN GROUP R O B E R T S O N + M A R K S ARCHITECTS | 55

APPENDIX 12 - EASEMENT FOR OIL PIPELINE:

