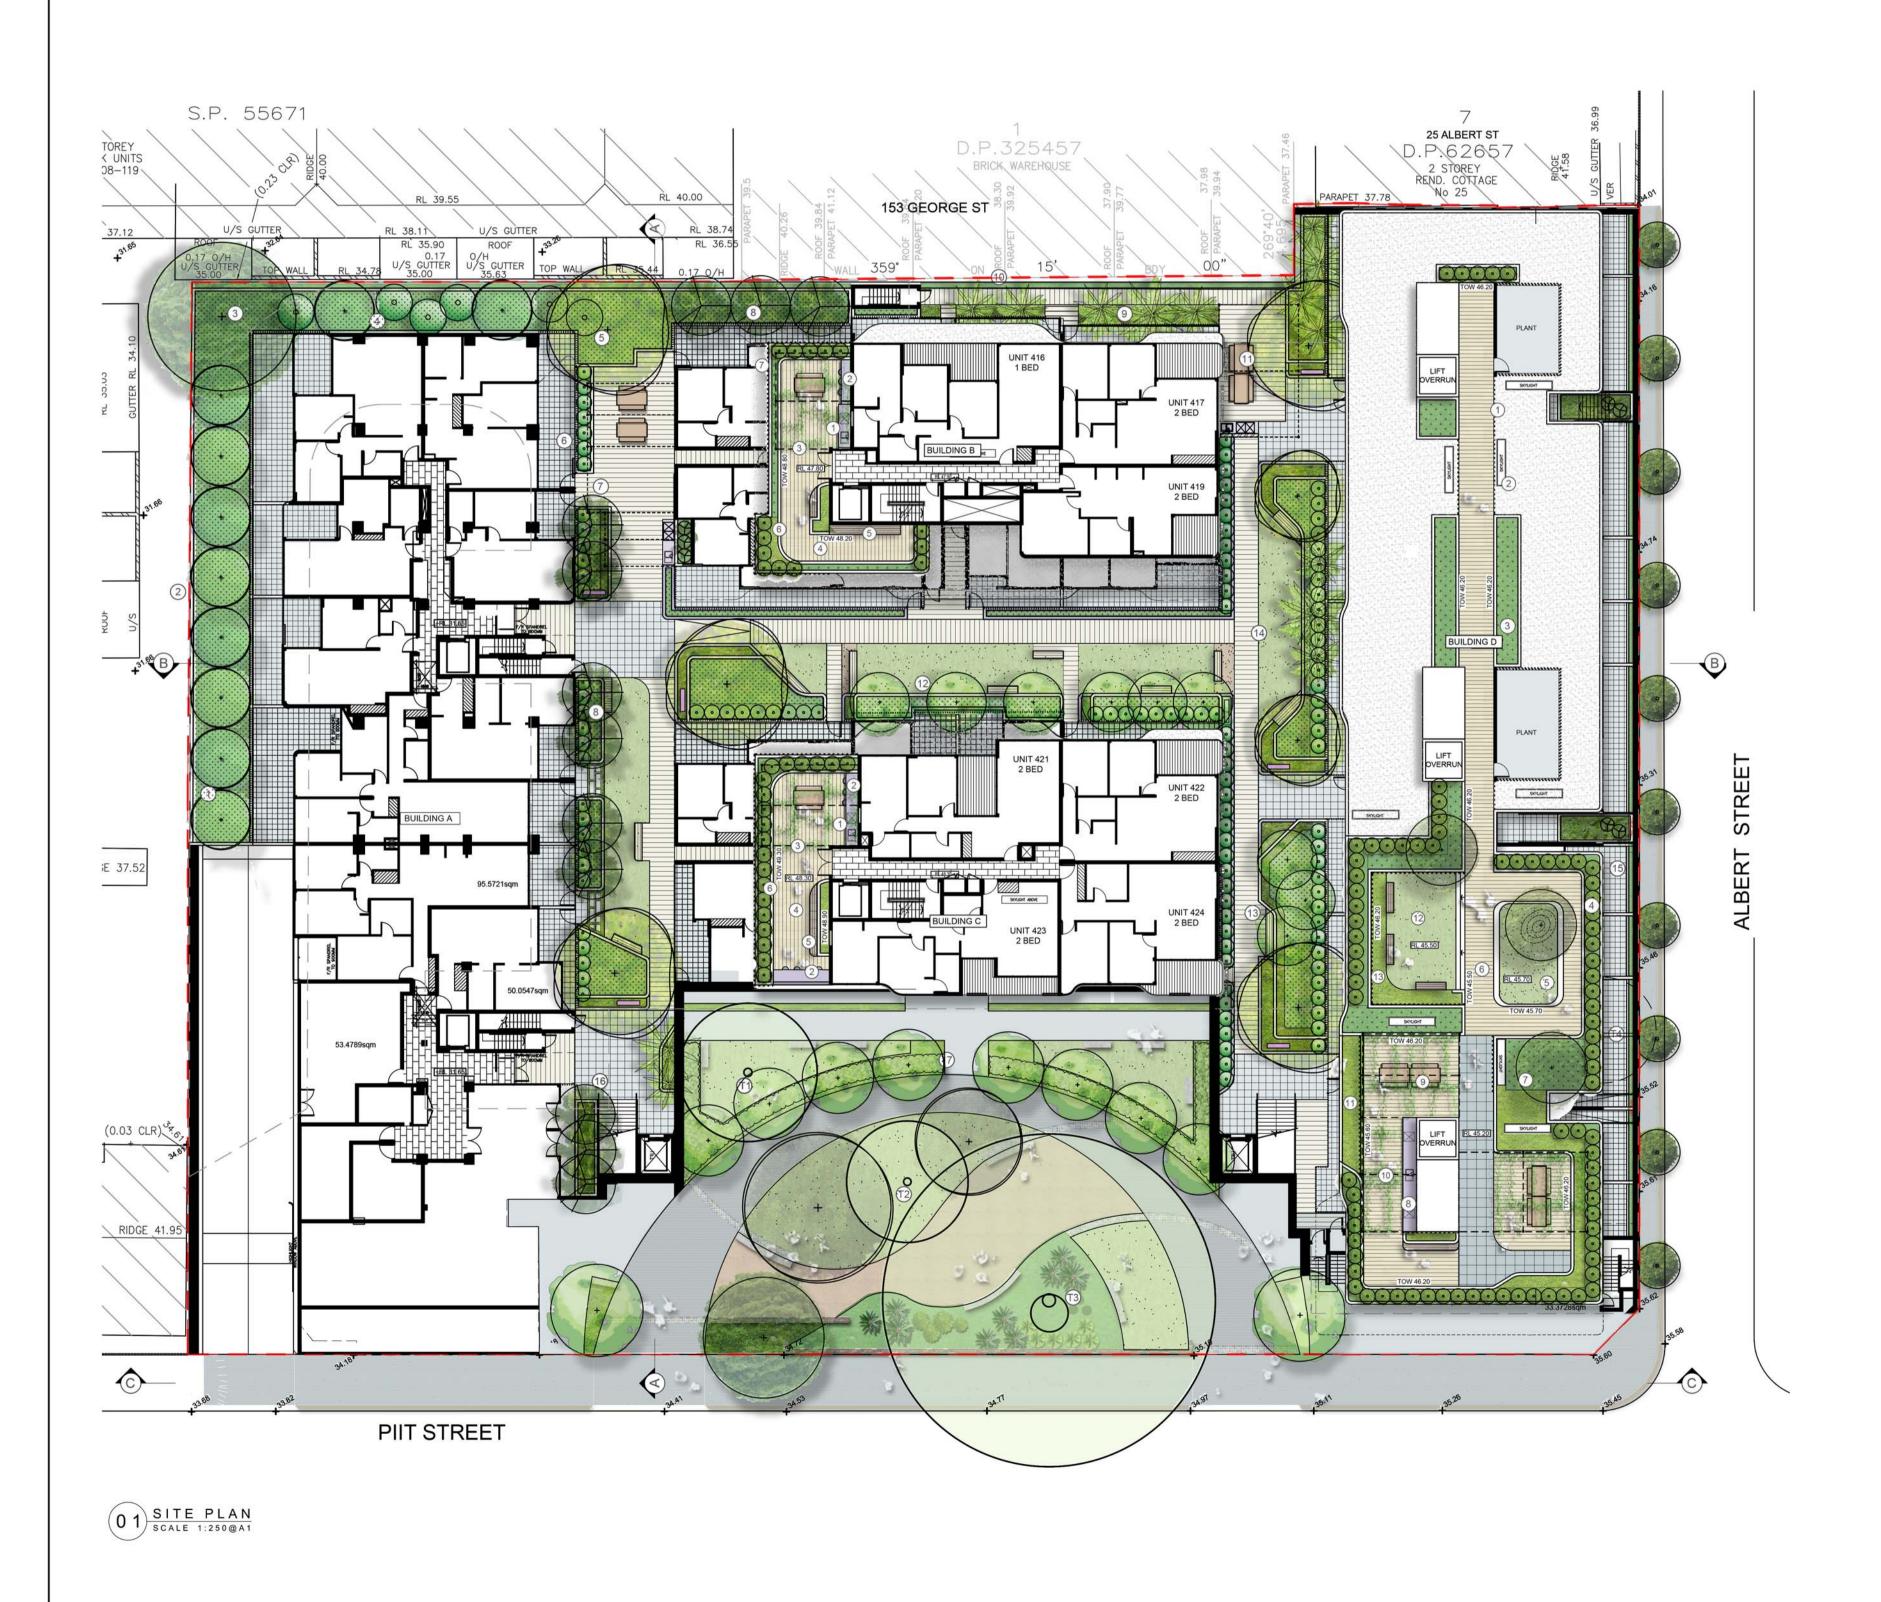
RACHEL FORSTER APARTMENTS

134-144 PITT STREET, REDFERN NSW 2016

LANDSCAPE CONCEPT PLANS

ISSUE D - FOR DEVELOPMENT APPLICATION



DRAWING REGISTER

SITE AREA CALCULATIONS

GROUND + LOWER GROUND FLOOR = 475.5m2

TOTAL SITE AREA= 6922.9m2

DEEP SOIL PLANTED AREA

DWG NO.	TITLE	Scale
L_100	Cover Sheet/Site Plan	1:250
L_101	Lower Ground Floor Plan	1:200
L_102	Ground Floor Plan	1:200
L_103	Communal Roof Terraces	1:200
L_104	Sections/Elevations 01	1:200
L_105	Sections/Elevations 02	As shown

PLANTING ON STRUCTURE GROUND + LOWER GROUND FLOOR = 783.6m2 ROOF TERRACES (BILLIDING B+C+D) = 274.2m2 TOTAL PLANTED AREAS (INCLUDING TURF) = 1533.3m2 *22% OF TOTAL SITE AREA PLANTING ON STRUCTURE BUILDING B BUILDING B BUILDING B BUILDING B

BUILDING C

02 AREA DIAGRAM SCALE 1:500@A1

PIIT STREET

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Issue	Description	Drawn	Check	Date
Α	CONCEPT FOR REVIEW	BL	LB	07.07.201
В	DRAFT FOR REVIEW	TC	BL	22.07.201
С	ISSUE FOR DA	TC	BL	18.08.201
D	UPDATED DA ISSUE	TC	BL	16.06.201
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ey Plan:

KAYMET PTY LTD

Project:

RACHEL FORSTER APARTMENTS
134 PITT STREET
REDFERN, NSW 2000

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Formed Gardens Pty Ltd
ABN 29 123 977 702

DEVELOPMENT APPLICATION

COVER SHEET AND
SITE PLAN

 Scale: 1:250 @ A1
 0 1 2 4 6 10m

 Job Number:
 Drawing Number:
 Rev:

 FG 16 432
 L_100
 D



tensioned wire trellis system. Courtyards to be stone tiled with low feature planters (beneath lobby entry ramps) to sustain shade loving native fern and

- 16. Ground floor public space access- Access steps and lift to ground floor public spaces. Access via security gate/intercom, refer to architectural
- 17. Ground floor public spaces- Refer to Ground floor plan (L_102)
- 9. Tree fern groves- Tall native tree ferns (Cyathea australis) in raised planterboxes for overhead canopy along boardwalk access paths. Mass foliage
- plants and accents beneath 2. Boundary fencing- Selected boundary fencing on top of planterbox wall to secure site. NOTE- All boundary fencing to be selected in coordination with 10. Warehouse vista- Preserve vista of remnant brick warehouse wall. Preserve existing signage, remove unwanted examples of graffiti and weed species
 - causing damage to structure
 - 11. Communal entertaining space 2- Secondary LG floor entertaining space. Open pergola over table settings and built-in cooking facilities 12. Avenue plantings- Small to medium size deciduous flowering trees (Lagerstroemia + Malus sp) to create avenues along access boardwalks.
 - 13. Seating hubs- Brick walling to 500mm high. Match brickwork finish to architectural detailing, timber slats on top of seats. Incorporate mass grass and accent plantings in low planters- Way finding signs in low planter boxes adjacent to lobby/ building entrances

Screening shrubs and grasses beneath for low level privacy to private courtyards- Open lawn area with benches in front for passive recreation

7. Communal entertaining space 1- Communal entertaining space. Cooking + dining facilities beneath open pergola structure. Fixed table settings and bbq + sink to cater for groups and intimate gatherings. Paving treatments to be hard wearing stone tile

neighbouring properties. Final fencing type TBC after negotiations

understorey plantings (Callistemon, Callicoma, Ceratopetalum sp)

available soil volumes

3. Tall native canopy trees-Local native canopy specimens in deep soil (Corymbia gummifera)

4. Boundary screen plantings- Informal screen planting along Western boundary within deep soil planterboxes. Tall native screening trees with mass

6. Private courtyards- Private courtyards to lower ground floor dwellings. Selected stone tiled finish with 1.8m privacy screens + planting to perimeters.

5. Specimen trees- Scattered signature flowering trees at key points throughout common gardens. Medium size trees selected to be suitable for

14. Through site link paths + Lawn inserts - Timber or composite boards as access paths through lower ground floor common areas. Ramp as required to accessible grades to meet building lobbies. Ornamental lawn spaces along boardwalks, provide minimum 300mm soil profile over structure

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Retain

Retain

Relocate as per plan

Approx mature Plant Installation

As plan

800mm

800mm

800mm

500mm

As plan

400mm

1.2m

1.2m

1.2m

300mm

600mm

300mm

500mm

500mm

400mm

500mm

400mm

400mm

600mm

600mm

600mm

600mm

600mm 200mm

600mm 200mm

As plan 1.5m Trunk

600mm 200mm

100L

45L

45L

200L

100L

100L

100L

200L

200L

200L

200mm

200mm

200mm

140mm

300mm

200mm

200mm

200mm

200mm

140mm

100mm

140mm

140mm

140mm

140mm

140mm

140mm

140mm

140mm

20mm

140mm

100mm

Height x Width (M) centres

8 x 6

15 x 10

8 x 5

5 x 3

5 x 3

8 x 5

10 x 5

8 x 5

8 x 5

10 x 10

6 x 4

6 x 4

8 x 4

1.5 x 1.0

1.8 x 1.0

1.8 x 1.0

1.0 x 1.0

3 x 1

 0.8×0.8

1.8 x 0.4

4.0 x 1.0

8.0 x 4.0

1.2 x 1.0

1.5 x 1.0

1.5 x 1.0

 0.8×0.8

 0.3×0.3

Groundcover

 0.3×0.3

Scrambler

 0.7×0.7

 0.7×0.7

Scrambler

 0.2×0.2

 0.3×0.6

Climber

0.6 x 0.6

 0.6×0.6

Groundcover

Camphor laurel

Lophostemon confertus

Cinamomum camphora

Alexander Palm

Coastal Banksia

NSW Christams Bush

Red Bloodwood

Black Wattle

Blueberry Ash

Dwarf Flowering Gum

Bottlebrush

Quandong

Kentia Palm

Jacaranda

Crepe Myrtle

Crepe Myrtle

Snow pear

Dwarf wattle

Native ginger

Native ginger

Grey Myrtle

Palm Lily

Gymea Lily

Dwarf Nerium

Rice Flower

Coastal Rosmary

Kidney Creeper

False Sarsparilla

Katrinus Delux

Dusky Coral Pea

LimeTuff Iomandra

Creeping boobiala

Rasp Fern

Club Rush

Star Jasmine

Native violet

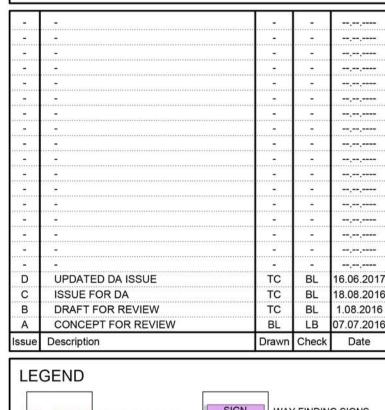
Wallum Banksia

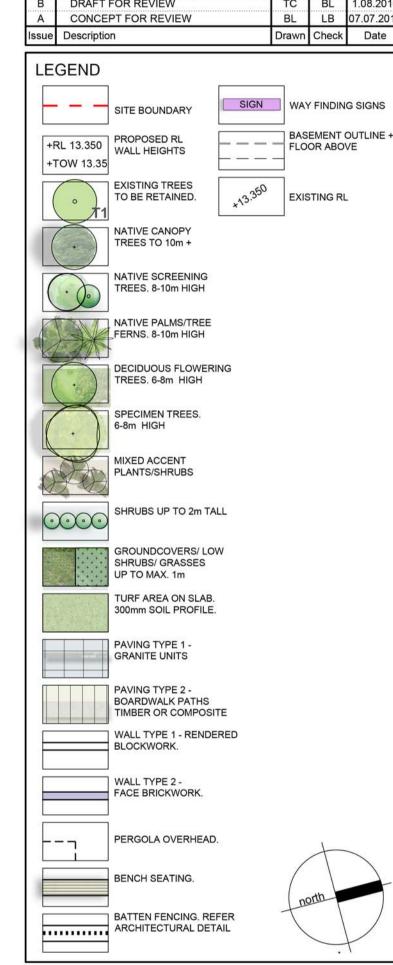
Heath Banksia

Rough Tree Fern

Plumeria rubra

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Formed Gardens Pty Ltd

ABN 29 123 977 702

DEVELOPMENT APPLICATION

LANDSCAPE CONCEPTS LOWER GROUND FLOOR PLAN

L_101 D

FG 16 432



EXISTING TREE REGISTER Tree number | Botanical Name Common Name Lophostemon confertus Retain Cinamomum camphora Camphor laurel Retain Plumeria rubra Relocate as per plan

As plan

As plan

300mm

500mm

500mm

400mm

500mm

400mm

400mm

600mm

140mm

140mm

140mm

140mm

140mm

140mm

140mm

100mm

 0.3×0.3

Scrambler

 0.7×0.7

 0.7×0.7

Scrambler

 0.5×0.5

 0.2×0.6

Groundcover

* Note: trees to be retained are to be protected in accordace with AS 4970 and existing arborist report

PROPOSED PLANT SCHEDULE- GROUND FLOOR Approx mature Plant Installation Height x Width (M) centres Trees/Palms Corymbia maculata Spotted Gum *Eleocarpus reticulatus Blueberry Ash 8 x 5

15 x 5 As plan Scribbly Gum Eucalyptus haemastoma Water Gum 10 x 5 As plan 200L Tristaniopsis laurina Plumena sp (extg-transplanted) Frangipani 6 x 4 As plan Existing Pyrus 'Capital' 10 x 4 As plan 100L Screen/Shrub/Accents Acacia fimbriata 'Dwarf 1.5 x 1.0 Dwarf wattle Asplenium nidus Birds Nest Fern 1.0 x 1.0 1.2m 200mm 500mm 140mm Backhousea myrtifolia Grey Myrtle 1.0 x 1.0 300mm As plan Wallum Banksia 3 x 1 Banksia aemulea 600mm 200mm Banksia ericfolia Heath Banksia 0.8×0.8 1.8 x 0.4 400mm Cordyline glauca 600mm Cordyline petiolaris Palm Lily 4.0 x 1.0 200mm 1.2 x 1.0 1.2m Doryanthes excelsa 200mm Gymea Lily Ozothamnus diosmifolius Rice Flower 1.5 x 1.0 1.2m 200mm Vibumum odoratissimum Sweet Viburnum 1.8 x 1.0 8.0 600mm 200mm Westringia fruticosa Coastal Rosmary 8.0×8.0 Groundcovers and Climbers Dianella caerulea 0.3×0.3 600mm Dichondra repens Kidney Creeper Groundcover 600mm Diets robinsoniana Lord Howe Iris 0.6×0.6

** Street tree replacement- TBC with Council preferred species

Rasp Fem

Club Rush

False Sarsparilla

Katrinus Delux

Dusky Coral Pea

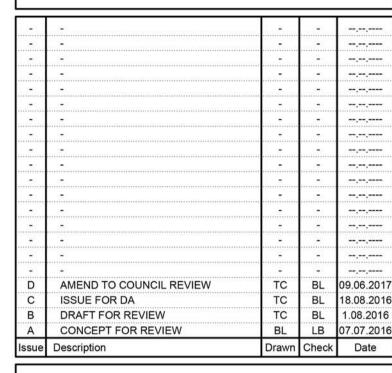
LimeTuff Iomandra

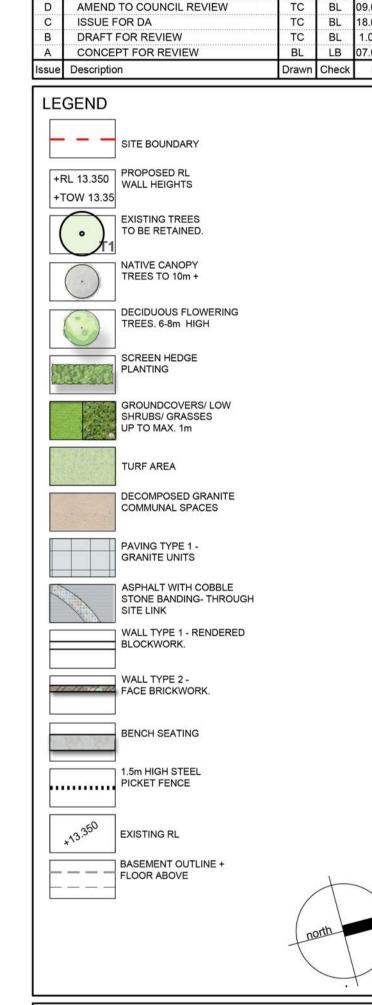
Creeping boobiala

Native violet

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DEVELOPMENT APPLICATION

Drawing Name:

LANDSCAPE CONCEPTS GROUND FLOOR PLAN

Scale: 1:200 @ A1 L_102 FG 16 432

12. 1.5m steel picket fence + gates- fence to separate public space and residents communal space

- 13. Albert St pedestrian footway- Remove existing concrete footway and install asphalt paving. Kerbstones to be new sandstone- subject to Council directives. Small street trees- Elaeocarpus reticulatus (@ 7.5m centres) along narrow pedestrian footway- Council to advise. All footway treatments to satisfy requirements as per Sydney Streets Code 2103 (Local Areas)
- 14. Entries to Albert street terraces- Entry ramps to building D lobbies on accessible grades. Refer to architectural detailing for site indentification signage, letterboxes and security provisions
- 15. Albert St walling and balustrades- Retaining wall along Albert St footway to meet existing footpath grades and levels. Decorative
- Sunken courtyards- Refer to lower ground floor plan (L_101)

balustrade/screens along top of wall to architects detail

17. Residential communal gardens- Refer to Lower ground floor plan (L_101)

- 1. Pitt St pedestrian footway- Retain all sandstone kerbing, consolidate/infill with replacement sandstone kerbing where required- Council to advise. Make good to existing asphalt footway to council requirements. Retain all existing street furniture and services, install new infill type lids to all pits as required. All footway treatments to satisfy requirements as per Sydney Streets Code 2103 (Local Areas)
- 2. Avenue of deciduous flowering trees Pyrus 'Capital' hedging + mass plantings below to screen residents communal open space
- 3. Shared access way through new public space- Curved asphalt access pathway to reference existing asphalt driveway to old hospital entrance. Incorporate cobblestone banding and possible interpretive detailing into ground plane as reference of site history
- 4. Entry garden bed- Transplanted Plumeria Sp. (T4) as entry specimen within low mass planting of grasses/groundcovers. Incorporate non-intrusive lighting to highlight specimen tree and associated signage walling
- 5. Site signage and heritage interpretation wall- New 1.5m high interpretive wall to detail former site use and historical significance. Match brickwork treatments to existing precedents on site. Wall to form part of interpretation strategy to future detail
- 6. New public open space- Public park space to consist of primary open lawn space with existing and additional native canopy trees overhead, mass planting displays beneath existing Cinamomum camphora (T3), seating provisions and non-instrusive lighting to ensure safe access and surveillance to the space. All works beneath existing Lophostemon cofertus (T2) to be in keeping with arborist recommendations
- 7. Private forecourt Building C- open lawn areas with seating benches for passive recreation- Retain existing Lophostemon confertus (T1) as per arborist recommendations
- 8. New public courtyard- Decomposed granite permeable surface beneath existing canopy trees. Provisions for seating along the link with potential market stall + community use space. Incorporate non-invasive lighting scheme and power provisions to facilitate mixed use
- 9. Existing brick wall- Retain and repair existing remnant brick wall, project engineer to confirm integrity of wall. All plantings behind existing wall to be low shrubs/grasses/groundcovers (maintained to 600mm high) to maintain casual surveillance and ensure connectivity between streetscape, the new public space, and the proposed built form. All works beneath existing Cinamomum camphora (T3) to be in keeping with arborist recommendations
- 10. Secondary lawn and rest space- Create secondary lawn space with seating provisions. Grade turf levels as necessary to preserve existing levels around existing Cinamomum camphora (T3)
- 11. Screen planting to private courtyards Screen planting to 2m with privacy screen/ fence for ground floor private courtyards



Height x Width (M) centres Size Trees/Tall shrubs Banksia integrifolia Coast Banksia Old Man Banksia As plan 300mm Banksia aemulea 4 x 3 Brachychiton rupestris QLD Bottle tree 6 x 4 As plan 5 x 4 100L Eucalyptus 'Summer beauty' Dwarf Gum As plan Shrub/Accents 1.2m Grevillea iaspicula 1.5 x 1.0 200mm Wee Jasper grevillea Erisotemon myoporoides Wax Flower 1.0 x 1.0 1.2m 1.2m Ozothamnus diosmifolius Everlasting daisy 1.2 x 1.0 200mm 600mm 200mm Thryptomene saxicola Heath myrtle 0.8×0.8 600mm 200mm Westringia fruticosa Coastal Rosmary 0.8×0.8 600mm 300mm 1.2 x 1.2 Xanthorrhoea resinosa Grass tree Groundcovers and Climbers Dianella caerulea 'Streetscape' 600mm 0.6 x 0.6 Lord How Iris Dietes robinsoniana Groundcover 200mm Carpobrotus glaucescens 500mm 140mm Hibbertia scandens Guinea flower Scrambler 400mm 140mm LimeTuff Iomandra 0.6 x 0.6 Lomandra 'Lime tuff' Myoporum parvifolium Creeping boobiala 0.3×0.6 400mm 140mm 400mm 140mm Pandorea pandorana 'Lemon Bells' Wonga Wonga Vine climber Pennisetum 'Nafray' 0.6 x 0.6 400mm Foxtail grass Themeda australis Kangaroo grass 0.6×0.6 400mm 140mm As plan 200mm Vitis vinifera climber Ornamental grape Viola hederacea Native violet Groundcover 600mm 100mm

Approx mature Plant Installation

PROPOSED PLANT SCHEDULE- ROOF TERRACES

LANDSCAPE NOTES

BUILDING B & C- COMMUNAL ROOF TERRACES

- 1. Cooking and dining facilities- Built-in kitchen facilities, electric BBQ + sink, set into bench unit with storage below. Timber or composite decking boards as ground plane finish
- 2. Bar style seating- Casual seating space with built-in bar style table and stools
- 3. Shade structure- Lightweight steel, open framed pergola with stainless steel wiring as trellis. Train deciduous climbing species over (Vitis vinifera) for winter solar access/summer shade
- 4. Sun deck- Open timber terrace for passive relaxation
- 5. Oversize seating- Built-in daybed/bed seating. Hardwood timbers over steel frame. Allow for led strip lighting beneath
- 6. Deep soil screen planting- 1m deep perimeter planterboxes to sustain low maintenance shrubs and grasses to enclose the terrace. All species selected for low water and pruning requirements post establishment (refer schedules). NOTE- All planterboxes are designed to be generally maintained from a standing position within the terraces. Contractor to install harness points for any works at height required to the applicable BCA
- 7. Fencing/Screening- Install decorative screens to form balustrade at any climb point. Match batten screens to architectural detailing

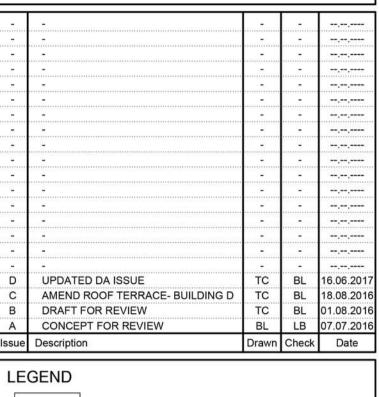
LANDSCAPE NOTES **BUILDING D-COMMUNAL ROOF TERRACE**

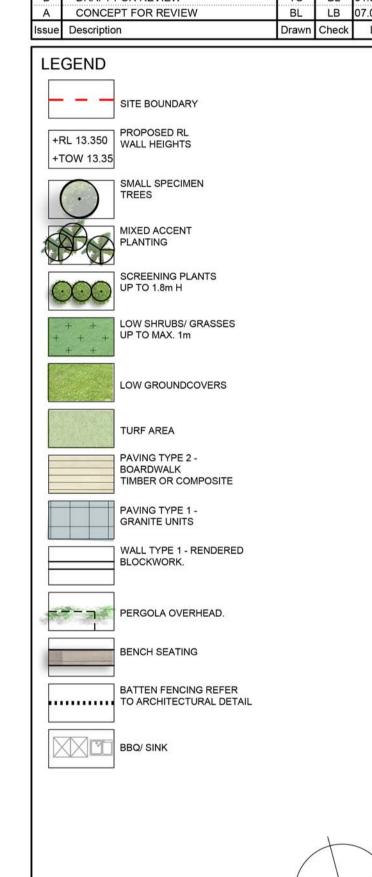
- 1. Batten fence/ screens to 1.5m high
- 2. Skylights as per architects details 3. Deep soil planterboxes 1- Deep soil planterboxes (1m depth)- Plant with native grasses up to 500mm high.
- 4. Deep soil planterboxes 2- Perimeter deep soil planterboxes (1m depth) to roof terrace perimeters to facilitate small native trees, shrubs and mass groundcovers tp provide screening to the terrace. All species selected for low water and pruning requirements post establishment (refer schedules) NOTE- All planterboxes are designed to be generally maintained from a standing position within the terraces. Contractor to install harness points for any works at height required to the applicable BCA codes and Aust. Standards
- 5. Turf island planter- Raised island planter with lawn surface and specimen tree (Brachychiton rupestris) as feature. Mound soils up gently around tree base to achieve soil depths. Wide 500mm lip along 2 sides as additional bench seating
- 6. Central Boardwalk- Selected timber or composite board as access way
- 7. Low planting around skylights- Maximum 500mm- refer to plant schedule

- 8. Cooking and dining facilities- Built-in kitchen facilities, electric BBQ x 2 + sink, set into bench unit with storage below.
- 9. Fixed table settings for communal use- Meeting/ dining spaces for residents
- 10. Shade structure- Lightweight steel, open framed pergola with stainless steel wiring as trellis. Train flowering climbing species over Pandorea pandorana 'Lemon Bells'
- 11. Lookout point- Create break in parapet wall to facilitate view lines through to communal space on ground floor level. Balustrades as
- 12. Passive lawn space- Raised lawn space (2 risers- min. 300mm deep soil profile) as passive recreation space. Mass native grasses to perimeter with fixed bench seating.
- 13. Privacy screens- 1.8m high fixed batten screen to ensure privacy and eliminate overlooking issues

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REDFERN, NSW 2000

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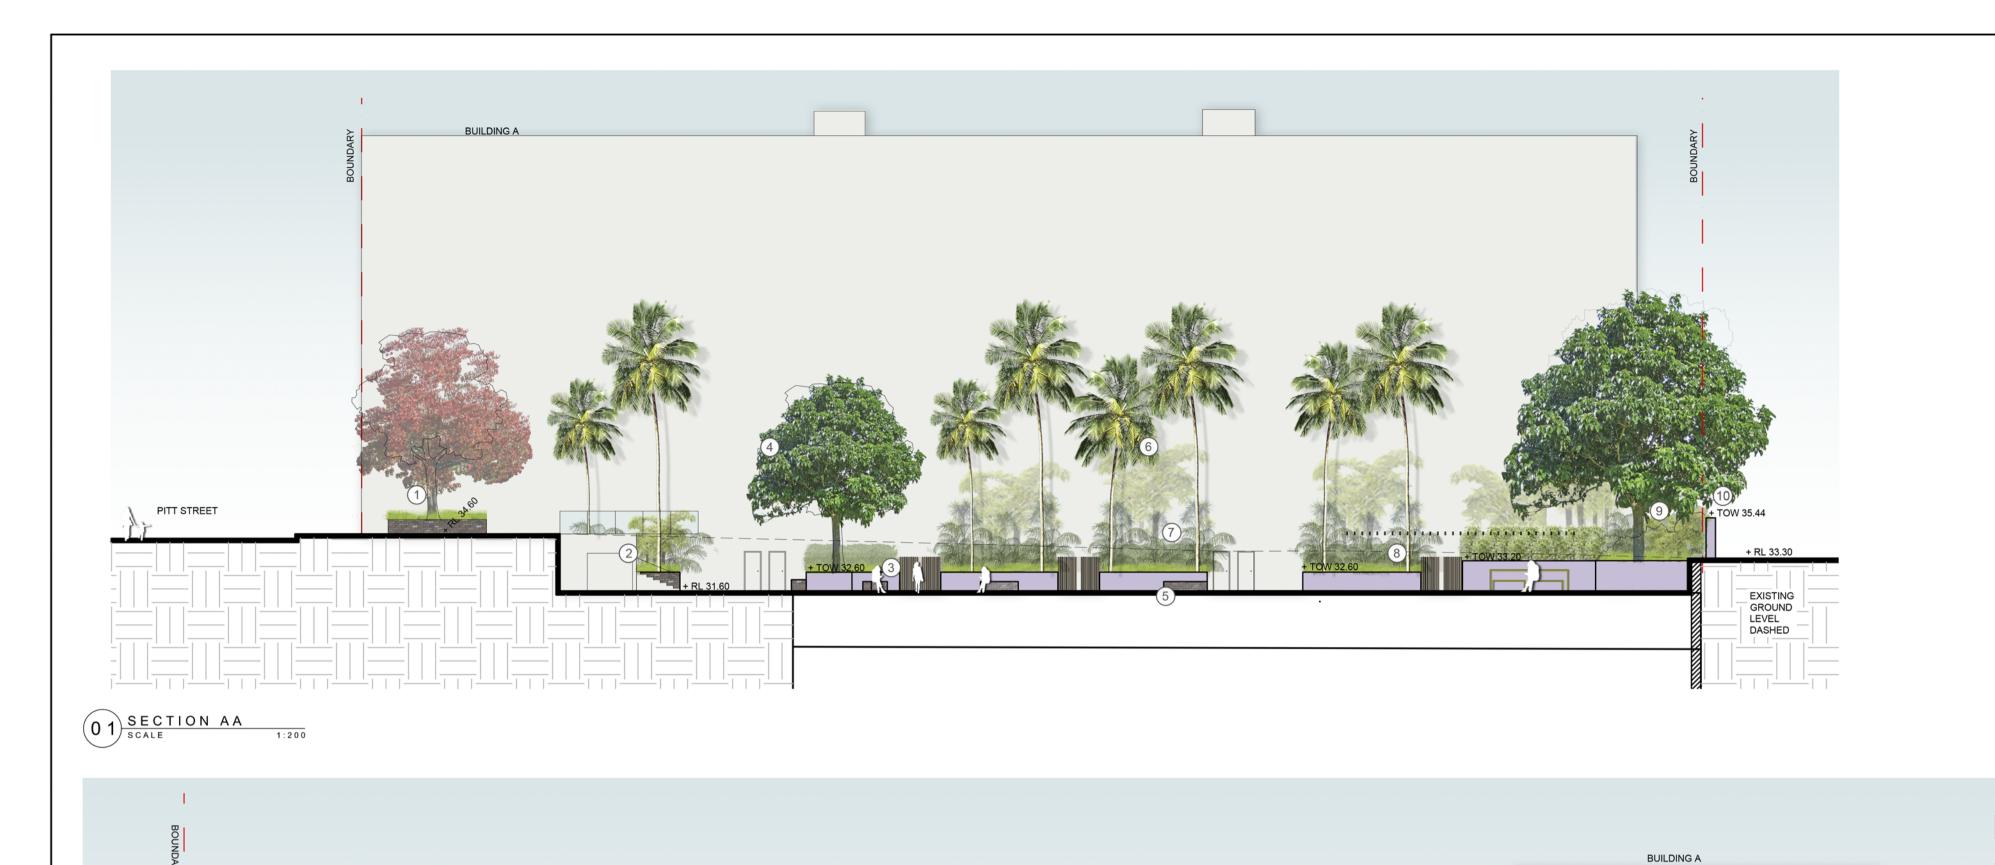
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DEVELOPMENT APPLICATION

LANDSCAPE CONCEPTS ROOF TERRACES- B, C & D

Scale: 1:200 @ A1 L_103 D FG 16 432



BUILDING B

SECTION BB

SECTION AA

Pitt St public forecourt
 Access to ground floor communal spaces

3. Entry to private courtyards
4. Specimen tree. Deciduous flowering
5. Bench seating points along boardwalks
6. Tall native palms for scale against Building C

Mix of tall accent + shrubs along boardwalk in raised planter boxes

Tall native screening trees in deep soil planters
 Neighbouring development. Remnant warehouse wall retained/protected

8. Communal entertaining space. Dining + cooking facilities beneath pergola structure

KEY:

- Narrow planters for climbers to cover boundary wall in sunken courtyards
 Specimen tree. Deciduous flowering
- Communal lawn spaces for passive recreation

 Avenue of small deciduous flowering trees along boardwalks in raised planter boxes Entry to private courtyards
- Bench seating points throughout

 Mid level screen plantings for privacy to courtyards
- 8. Specime flowering tree in deep soil planter9. Tall native palms for scale against Building A

SECTION CC

- Tall native rainforest trees for scale against Building A. Shade tolerant understorey plantings beneath
 Medium sized deciduous flowering trees for seasonal display
 Interpretive wall + site signature. Specimen tree with mass plantings
- 4. Existing brick wall site frontage. Retain/repair
- Existing blick wail site floritage. Retail frepail
 Pitt Street publicly accessible community space
 Existing Camphor laurel- T3 tree to be retained
 Tall mature trees in deep soil along shared access way
- 8. Plrivate communal gardens to Building C
- 9. Albert St footway- upgraded footpath + new small street trees

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16.06.2017

1.8.2016

TC BL 18.08.2016

Drawn Check Date

to be reported to the Project Manager or Landscape Architect prior to commencing work. Do not scale this drawing. Any required dimensions not shown shall be referred to the Landscape Architect for confirmation.

UPDATED DA ISSUE

DRAFT FOR REVIEW CONCEPT FOR REVIEW

ISSUE FOR DA

Issue Description

KAYMET PTY LTD

RACHEL FORSTER APARTMENTS 134 PITT STREET REDFERN, NSW 2000

formed gardens

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DEVELOPMENT APPLICATION

Drawing Name:

LANDSCAPE CONCEPTS SECTIONS/ELEVATIONS 01

Scale: 1:200 @ A1 FG 16 432

BUILDING A ALBERT STREET BUILDING D

03 SECTION CC

ALBERT STREET

02 SECTION BB

BUILDING D



SECTION DD

- 1m high planter boxes with perimeter screen planting to ensure privacy and prevent overlooking
- Decorative steel shade structure overhead with climbing/flowering plant species
- Oversize communal dining settings adjacent to outdoor cooking facilities Low plantings around skylights to max 0.5m high
- Turf island to 500mm high. Mound soils up to create additional depth around specimen tree Raised lawn area- 2 steps (300mm min soil depth). Bench seating with perimeter native grass plantings

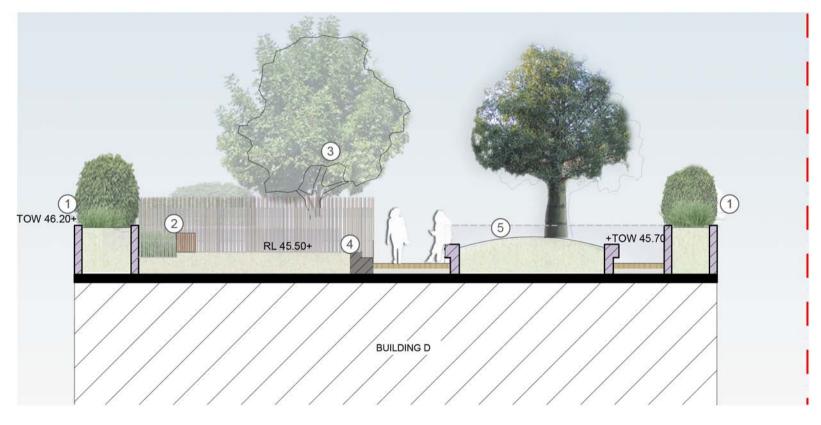
1m high planter boxes with perimeter screen planting to ensure privacy and prevent overlooking

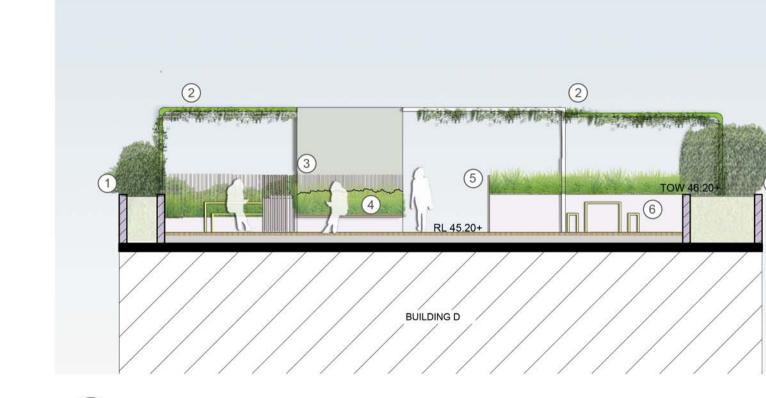
Specimen tree in deep soil planterbox. Mass grasses and spreading groundcovers beneath.

5. Turf island to 500mm high. Mound soils up to create additional depth around specimen tree

- Specimen tree in deep soil planterbox. Mass grasses and spreading groundcovers beneath
- 8. 1m high planter boxes with mass native grass species to line boardwalk









SECTION FF

SECTION EE

- Perimeter screen planting to ensure privacy and prevent overlooking Decorative steel shade structure overhead with climbing/flowering plant species
- Communal outdoor cooking facilities
- Raised planter box with built-it in seating edge, batten timber screen behind Batten style screen along boardwalk to screen skylights

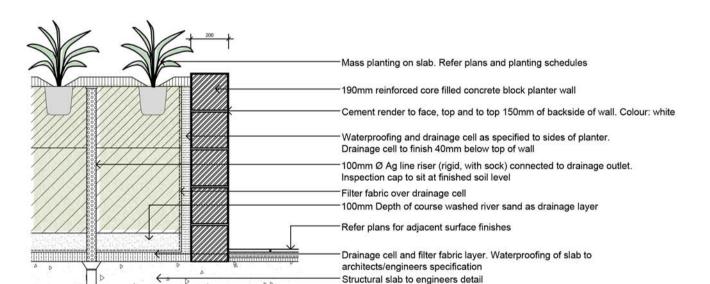
Bench seating for passive recreation with low grass planting behind

Raised lawn area- 2 steps (300mm min soil depth)

6. Oversize communal dining settings

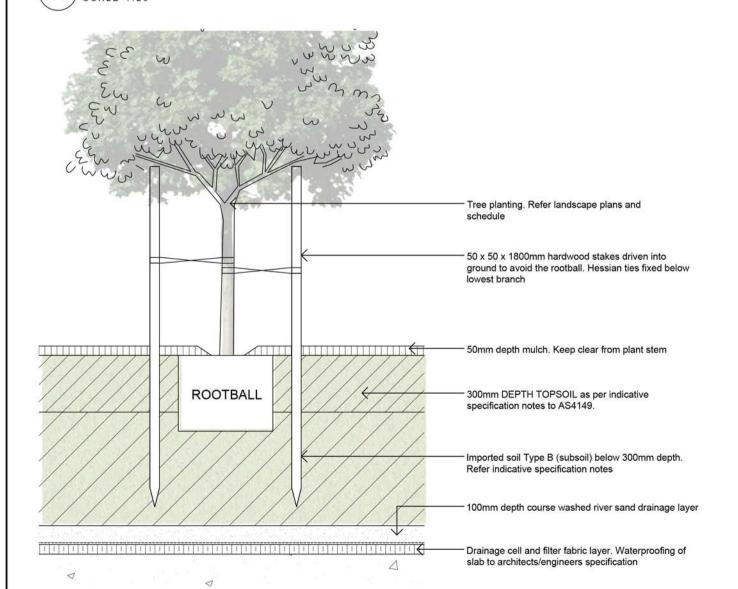






Connection to drainage as per engineers requirements

(07) TYPICAL PODIUM PLANTING PROFILE- SHRUB/ACCENST/GRASSES



TYPICAL PODIUM PLANTING PROFILE- TREES

INDICATIVE LANDSCAPE NOTES

1.0 GENERAL

All landscape works are to be carried out by a qualified Landscape tradespersons with the appropriate skill set and accreditation. Any changes to the required works are to be approved by the Project Landscape Architect.

All works around existing trees on site are to be in accordance with the recommendations of the project arborist and with the arborist report by Landscape Matirx

All paving and tree works within the public domain are to be in accordance with Sydney Street Codes 2013 and City of Sydney's Public Domain Technical manual. All treatments noted on plan are subject to review and to be confirmed/conditioned by Council.

All plantings on grade are to be a mix of cultivated site soils and imported organic mix. Improve site soils with bulk organic matter, cow manure and pelletised organic fertiliser during cultivation and before planting. Where required, supplement site soils with imported

- Top Soil: Cultivated site soil with imported organic manures, topped up with locally available Native garden mix (Low phosphorus). - Sub soil: Break up any existing heavy clay soils and improve with Gypsum

All plantings on podium are to be the following:

Topsoil profile: Benedicts Smartmix # 4 - Lightweight planter box mix: top 300 - 400mm of soil profile Subsoil profile: Benedicts Smartmix #5 - Lightweight planter box subsoil mix: below top 300mm of soil profile (depth varies) Drainage layer: 75-100mm depth washed river sand

The following minimum soil depths are to be achieved: ≈300-450mm for groundcovers ≈450-600mm for small shrubs ≈600-750mm for medium shrubs ≈750-900mm for small trees

4.0 DRAINAGE TO PLANTERBOXES & RETAINING WALLS

Supply and install drainage provisions behind all planter walls. The Landscape Contractor shall check the waterproofing is installed as per manufacturers recommendations, and notify of any breaks or inadequacies prior to installation. Supply and install polypropylene cellular drainage cell complete with continuous geotextile filter fabric liner to back of all planterbox walls and floors, in accordance with manufacturer's instructions and details.

- Planter Walls: VersiDrain 8 Geo high density polyethylene dimpled drain sheet by Elmich Australia P/L - Planter Floors: VersiCell recycled polypropylene drainage cell by Elmich Australia P/L

Drainage cell and filter fabric shall extend across up planter walls to the underside of the mulch layer. Geotextile filter fabric is to be installed over all drainage cell material. Allow to tape the fabric over the top of the planter walls to ensure soil mix does not escape into drainage outlets/holes.

All planting areas, unless otherwise specified, to be mulched with a course and open mulch to 50mm depth with catchment dish to be left around base of all plants. Mulch to be composted bark and wood waste, free from any diseased or noxious plant material- equivalent to 'Forest Blend' from Australian Native Landscapes

Turf shall be delivered to site as 25mm minimum thick cut rolls. Obtain turf from a specialist grower of cultivated turf. Provide turf of even thickness, free from weeds and other foreign matter. Lay the turf in stretcher pattern with the joints staggered and close butted. Finish flush, after tamping, with adjacent finished surfaces of ground. Do not allow newly turf areas to dry out between waterings throughout establishment period.

Private communal spaces = Soft Leaf Buffalo or approved equal

Public communal spaces = Soft Leaf Buffalo or approved equal Synthetic lawn (SE area of Roof terrace) = 'Summer Envy' By Tigerturf or approved equal, installed to manufacturers specification

Supply all plants in accordance with the landscape schedules, which have the following characteristics:

- Large healthy root systems, with no evidence of root curl, restriction or damage Vigorous, well established, free from disease and pests, of good form consistent with the species or variety · Hardened off, not soft or forced, and suitable for planting in the natural climatic conditions prevailing at the site - Trees, unless required to be multi-stemmed, shall have a single leading shoot

Install steel strip edging at interface between all turf and planted areas.

Material: 100 x 4mm Galvanised flat bar. Fixings: 300 x 10mmØ Galvanised deformed bar welded to the flat @ max. 1.0m centres and 300mm from ends.

8.0 IRRIGATION

Automatic drip irrigation watering system to be selected and installed to extend to all landscaped areas. The Landscape Contractor is to liaise with council as necessary, to ensure that the irrigation conforms with all Sydney Water, Council and Australian Standards and Regulations. Contractor is to use collected rainwater wherever possible.

A schematic design of the proposed irrigation system is to be prepared by the contractor, showing solenoids, pipe diameters, and all drip and sprinker attachment types (including spray/head angle), for review by the superintendent prior to installation

Provide an automatic controller that provides for two week scheduling and hourly multi-cycle operation. Programming shall be undertaken by the contractor who shall advise on the operation of the system. It shall be the contractor's responsibility to ensure and guarantee satisfactory operation of the irrigation system.

Provision of secure housing for the automatic irrigation controller to be located alongside the corresponding plant/services equipment store on site and in association with the landscape contractor and location confirmed by the Hydraulic consultant. Wiring to connect remote solenoid locations is to be provided, the controller shall be located in a dry place, protected from the weather, and all cable connections shall be made with waterproof connectors. Water supply points to be supplied by builder.

Implement a review of all irrigation systems after plant establishment and amend programmes and flows to suit the requirements of the established landscape.

10.0 PAVING

All paving is to be sealed with penetrative, water based sealer prior to installation. Refer to manufacturer's specification. Grade all external paving to even falls. Drain the surfaces away from structures and towards drainage outlets, or the surface run-off system provided, without ponding.

Pavements shall be constructed to the lines, profiles and cross sections shown and/or approved. Installed plus or minus 10mm from the correct level, plus or minus 3mm from a 3m straight edge laid in any direction on an area of uniform grade. *All selected stone is to comply with AS 4586 for slip resistance and be certified by supplier toR11 and R12 slip resistance. All step treads to have 5m pencil edge. Suppliers/contractor to provide certification at installation *Install TGSI's and nosing strips to AS 1428.1 & 4.1

*All paving and base courses to be certified by engineer prior to installation Types as noted on plan to be:

Type 1 & 2- Selected Granite tile/paver equivalent to 'Sesame grey' By Samstone P/L (T1-600mm2 T2- 600 x 400mm)

Type 3- Timber boards (Refer 1.0- Timber) Type 4- Segmental 'Brick style' unit paver (200 x 100 x 50) Note- Final selection to be coordinated with architectural finish Type 5- Decomposed granite. Compacted and stabilised, equal to 'Deco Gold' from Australian Native Landscapes Type 6- Asphalt with granite cobble banding. 'A' class finished asphaltic paving with 90mm2 granite cobble 'Sesame Grey' (mix of

'natural split' and 'exfoliated' finish) from Samstone P/L Type 7- Granite tile equivalent to 'Sesame grey' By Samstone P/L (600mm2 + 600 x 400mm)

Final paving selection TBC with architectural finishes

11.0 WALLING

All landscape walling/planters as noted on plan to be: Type 1- Corefilled blockwork with integrated colour render finish (white)

Type 2- Face brickwork (double) to match architectural finishes and existing remnant brickwork All finishes to be coordinated with architectural schedules

All footings to engineers details.

All subsurface walling and where masonry walls will be in contact with soils, back of walls to be waterproofed and treated as per item 3.0 All planterboxes at height to be fitted with harness points for maintenance access to BCA requirements

Supply and install decking in the configurations shown on the drawings. Decking materials shall be selected for durability and good long term appearance characteristics. Deck material shall be 150mm wide with butted end joints shall be avoided in favour of full length strips. All edges shall be either chamfered or arrised or pencil round. Decking shall be free of knots, shakes, splits and other blemishes that may affect the life of the material. Provide access panels made of deck strips where ever service access is required for drainage maintenance or other services located under the deck. Structural design to engineer's detail. Type to be 'Spotted Gum' hardwood in 140mm board OR Composite engineered product- Modwood or equivalent 'Silver Gum' wide

board in brushed finish.

Courtyard privacy screens + gates- Match to architectural details and finishes

Boundary fencing- Where new boundary fencing is required, type and final heights to be by negotiation with neighbouring parties and the

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The contractor shall check and verify all work on site (including work by others) before commencing the landscape installation. Any discrepancies are to be reported to the Project Manager or Landscape Architect prior to commencing work. Do not scale this drawing. Any required dimensions not shown shall be referred to the Landscape Architect for confirmation.

Issue	Description	Drawn	Check	Date
Α	CONCEPT FOR REVIEW	BL	LB	07.07.2016
В	DRAFT FOR REVIEW	TC	BL	1.8.2016
С	ISSUE FOR DA	TC	BL	18.8.2016
D	UPDATED DA ISSUE	DC	BL	16.06.2017
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Sheet 5 of 5

DEVELOPMENT APPLICATION

LANDSCAPE CONCEPTS SECTIONS/DETAILS

Scale: AS SHOWN Drawing Number: 105 D

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