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ARBORICULTURAL IMPACT ASSESSMENT TREE PROTECTION SPECIFICATION

Marrickville Metro Section 75W

Prepared for: AMP CAPITAL

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Revision A

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1.0 INTRODUCTION

1.1 Background

- 1.1.1 This Arboricultural Impact Assessment Report and Tree Protection Specification was prepared for AMP Capital in relation to the Section 75W Application for the Marrickville Metro Shopping Centre Redevelopment. The purpose of this Report is to undertake a Visual Tree Assessment¹ (VTA), determine the impact of the proposed works on the trees, and where appropriate, recommend the use of sensitive construction methods to minimise adverse impacts.
- 1.1.2 Previous Arboricultural Reports (Rev A - dated 19th February 2010, Rev B - dated 17th May 2010, Rev C - dated 23rd May 2010, Rev B – dated 17th December 2012) for the Marrickville Metro project have been prepared by treeiQ. Tree numbering from the previous reports has been used for consistency. All of the trees addressed within this Report have been reassessed.
- 1.1.3 In preparing this Report, the author is aware of and has taken into account the objectives of the *Marrickville DCP (2.20 Generic Provisions - Tree Management)*, *Marrickville Street Tree Masterplan (2014)*, *Australian Standard 4970 Protection of Trees on Development Sites (2009)*, *Australian Standard 4373 Pruning of Amenity Trees (2007)* and *Australian Standard 2303 Tree Stock for Landscape Use (2015)*.

Refer to Methodology (**Appendix 1**)

- 1.1.4 This impact assessment is based on an assessment of the following supplied documentation/plans only:

- Landscape Cover Sheet (Dwg No. 000/B) – prepared by Site Image, dated 27.09.17
- Landscape Character Plan (Dwg No. 002/B) – prepared by Site Image, dated 27.09.17
- Landscape Existing Tree Plan (Dwg No. 010/B) – prepared by Site Image, dated 27.09.17
- Landscape Masterplan (Dwg No. 100/B) – prepared by Site Image, dated 27.09.17
- Landscape Plan (Dwg No. 101/B) – prepared by Site Image, dated 27.09.17
- Landscape Plan (Dwg No. 102/B) – prepared by Site Image, dated 27.09.17
- Ground Floor Plan (EA106 Rev A) – prepared by Hames Sharley, dated 25/09/17
- Level 1 Floor Plan (EA107 Rev A) – prepared by Hames Sharley, dated 25/09/17
- Level 2 Floor Plan (EA108 Rev A) – prepared by Hames Sharley, dated 25/09/17
- Level 2A Floor Plan (EA109 Rev A) – prepared by Hames Sharley, dated 25/09/17
- Roof Plan (EA110 Rev A) – prepared by Hames Sharley, dated 25/09/17
- South & North Elevations (EA111 Rev A) – prepared by Hames Sharley, dated 25/09/17
- West & East Elevations (EA112 Rev A) – prepared by Hames Sharley, dated 25/09/17

Refer to Plans (**Appendix 2**)

1.2 The Proposal

- 1.2.1 The proposal is for a Section 75W Application for the Marrickville Metro Shopping Centre Redevelopment. The supplied plans show the proposed works in the vicinity of the existing trees include the:
- Demolition of existing structures and pavements
 - Construction of a new retail building
 - Installation of landscape treatments along the Smidmore Street, Edinburgh Road and Murray Street road reserve areas

Refer to Plans (**Appendix 2**)

¹ Mattheck & Breloer (2003)

2.0 RESULTS

2.1 The Site

- 2.1.1 The site is a commercial allotment located to the south of the existing Marrickville Metro Shopping Centre, and is bound by Smidmore Street to the north, Murray Street to the east, and Edinburgh Road to the south and west.
- 2.1.2 An existing warehouse building occupies the eastern area of the site and a smaller single commercial building is positioned in the centre-west.
- 2.1.3 The site is irregular in shape and is generally level.

2.2 The Trees

- 2.2.1 Forty one (41) trees (and groups of trees) were assessed using the Visual Tree Assessment² (VTA) criteria and notes, and consist of a mix of locally indigenous, Australian native and exotic species. With the exception of Trees 65-74 and 88, all of the trees are located within the road reserve areas and are managed by Inner West Council.
- 2.2.2 As required by Clause 2.3.2 of *Australian Standard 4970 (2009) Protection of Trees on Development Sites (AS-4970)*, each tree assessed has been allocated a Retention Value. The Retention Value is based on the tree's Useful Life Expectancy and Landscape Significance with consideration to its health, structural condition and site suitability. The Retention Values do not take into account any proposed development works and are not a schedule for tree retention or removal. The trees have been allocated one of the following Retention Values:
- Priority for Retention
 - Consider for Retention
 - Consider for Removal
 - Priority for Removal

Refer to Tree Assessment Schedule (**Appendix 3**)

- 2.2.3 A search of the BioNet Atlas of NSW Wildlife Database was undertaken in September 2017. Trees 79 and 83 *Eucalyptus nicholii* (Narrow Leaf Peppermint) were identified at the site and are listed as a *Vulnerable Species* under the NSW *Biodiversity Conservation Act (2016)* and the Commonwealth *Environment Protection and Biodiversity Conservation Act (1999)*.³ Tree 92 *Syzygium paniculatum* (Lillypilly) was identified at the site and is listed as an *Endangered Species* under the NSW *Biodiversity Conservation Act (2016)*.⁴ Based on their location within the road reserve, these trees are planted specimens and not a component of a locally indigenous vegetation community.

3.0 ARBORICULTURAL IMPACT ASSESSMENT

3.1 Trees 62-64

- 3.1.1 Trees 62-64 have been identified as *Ficus microcarpa* var. 'Hillii' (Hills Weeping Fig) and are located within the Western road reserve of Murray Street, near the junction of Smidmore Street. The trees have been allocated a moderate to high Landscape Significance and a Retention Value of *Consider for Retention*.
- 3.1.2 The supplied plans show no works are proposed within the Tree Protection Zone (TPZ) areas of Trees 62-64.

² Mattheck & Breloer (2003)

³ NSW Office of Environment and Heritage (2011)

⁴ NSW Environment & Heritage (2013)

3.2 Trees 65-67

3.2.1 Trees 65-67 have been identified as *Ficus microcarpa* var. 'Hillii' (Hills Weeping Fig) and are located on the northern side of Smidmore Street, adjacent to the existing shopping centre building. The trees have been allocated a high Landscape Significance and a Retention Value of *Consider for Retention*.

3.2.2 The supplied plans show that landscape works including the installation of new pavement surfaces and timber decking are proposed within the TPZ areas of Trees 65-67. The extent of works represents *Major Encroachments* as defined by AS-4970. Clause 3.3.4 of AS-4970 notes that design factors and tree sensitive methods can be used to minimise the impact of the encroachment.

3.2.3 Recommendations

The following methods are recommended within the TPZ areas of Trees 65-67 to minimise adverse impacts:

- Demolition of existing structures and pavements should be undertaken using tree sensitive methods. Where possible, existing underground structures should be left in-situ.
- Decking, walls and seating (and other structures as required) should be supported on isolated piered footings (with all other parts of the structures positioned above existing ground levels to minimise excavation and root loss). Excavation for the pier holes should be undertaken using tree sensitive methods (hand/hydrovac/airspade etc). Pier hole locations should be flexible to enable the retention of roots (>25mmØ, or as deemed necessary by the Project Arborist).
- Pavements (including sub-base materials) should be installed above or at existing grade and utilize existing sub-base layers where possible. Surfaces and sub-base materials should be thinned as required above roots (with appropriate root protection installed). The design and levels of pavements/kerbs should be modified to enable the retention of roots (>25mmØ, or as deemed necessary by the Project Arborist).
- Plant installation should be undertaken using hand tools and roots (>25mmØ) should be retained and protected. No mechanical cultivation/ripping of soils should be undertaken.

3.3 Tree 68

3.3.1 Tree 68 is a group of two (2) trees identified as *Acacia floribunda* (Sally Wattle) and are located on the northern side of Smidmore Street, adjacent to the existing vehicular entrance ramp. The trees have been allocated a low Landscape Significance and a Retention Value of *Priority for Removal*.

3.3.2 The supplied plans show no works are proposed within TPZ of Tree 68. However, given its Retention Value of *Priority for Removal*, consideration should be given to its removal and replacement as part of the proposed works.

3.4 Trees 69-74

3.4.1 Trees 69-74 have been identified as *Ficus microcarpa* var. 'Hillii' (Hills Weeping Fig) and are located on the northern side of Smidmore Street, near the junction of Edinburgh Road. The trees have been allocated a high Landscape Significance and a Retention Value of *Consider for Retention*.

3.4.2 The supplied plans show no works are proposed within the TPZ areas of Trees 69-74.

3.5 Trees 75-78

- 3.5.1 Trees 75-78 have been identified as *Corymbia citriodora* (Lemon Scented Gum) and are located within the southern road reserve of Smidmore Street, near the junction of Edinburgh Road. Trees 75 and 77 have been allocated a high Landscape Significance and a Retention Value of *Priority for Retention*. Trees 76 and 78 have been allocated a high Landscape Significance and a Retention Value of *Consider for Retention*.
- 3.5.2 The supplied plans show that demolition works, construction of a new retail building and footpath renewal works are proposed within the TPZ areas of Trees 75-78. The new building footprint falls outside of the trees' Structural Root Zone (SRZ) areas. The extent of works represents *Major Encroachments* as defined by AS-4970. Clause 3.3.4 of the AS-4970 outlines that the presence of existing or past structures or obstacles affecting root growth should be considered when determining the potential impact of the encroachment. A 300mm (approx.) high retaining wall is located along the north-western site boundary and adjacent to Trees 75-78. Within the site, the area to the rear of the retaining wall comprises of hard-stand. It is assumed the hardstand is supported on a 300mm deep (approx.) layer of compacted fill. It is likely that the spread of roots would have been partially restricted by the footing of the retaining wall and the sub-optimal growing conditions beneath the hardstand area.
- 3.5.3 Pruning of Trees 75-78 will be required to accommodate the new building. Due to the trees' crown form with limited lateral branching, the removal of a number of large diameter first and second order branches will be required. Trees 76-78 have a reduced crown densities indicating they may be subject to a degree of physiological stress. Particularly for these trees, the extent of pruning works proposed may impact tree vigour and reduce their Useful Life Expectancies. The pruning will also impact the trees' crown form and symmetry although this will be less evident when the trees are viewed from within the street. Refer to Pruning Specification (Section 3.13).

3.5.4 Recommendations

The following methods are recommended within the TPZ areas of Trees 75-78 to minimise adverse impacts to the trees:

- Demolition of existing structures and pavements should be undertaken using tree sensitive methods. Where possible, existing underground structures should be left in-situ. Where tree roots are in contact with, or have grown under existing structures or footings within SRZ areas, the structure/footing should remain in situ and be assessed by the Project Arborist to determine if they are potentially providing support to the trees' root systems.
- The new building should be supported on isolated piered footings (with all other parts of the structures positioned above existing ground levels) unless root investigations show no roots are present within the building footprint. Excavation for the pier holes should be undertaken using tree sensitive methods (hand/hydrovac/airspade etc). No excavation for footings should extend into the trees' SRZ areas.
- Pavements (including sub-base materials) should be installed above or at existing grade and utilize existing sub-base layers where possible. Surfaces and sub-base materials should be thinned as required above roots (with appropriate root protection installed). The design and levels of pavements/kerbs should be modified to enable the retention of roots (>25mmØ, or as deemed necessary by the Project Arborist).
- Plant installation should be undertaken using hand tools and roots (>25mmØ) should be retained and protected. No mechanical cultivation/ripping of soils should be undertaken within the TPZ.

3.6 Trees 79 & 83

- 3.6.1 Trees 79 and 83 have been identified as *Eucalyptus nicholii* (Narrow Leaf Peppermint) and are located within the southern road reserve of Smidmore Street. The trees have been allocated a moderate Landscape Significance and a Retention Value of *Consider for Retention*.
- 3.6.2 The supplied plans show Trees 79 and 83 are proposed for removal as part of the landscape treatment. Anecdotally, *Eucalyptus nicholii* are considered to be a relatively short lived species in the Sydney area. The assessment of Trees 79 and 83 has determined the trees' health to be fair based on the volume of epicormic growth and deadwood within their crowns, and reduced crown densities. Replacement planting using healthy, advanced-size specimens could replace the loss of amenity from tree removal within a medium timeframe.

3.7 Trees 80, 81 and 84

- 3.7.1 Trees 80, 81 and 84 have been identified as *Corymbia citriodora* (Lemon Scented Gum) and are located within the southern road reserve of Smidmore Street. Tree 80 has been allocated a high Landscape Significance and a Retention Value of *Consider for Retention*. Trees 81 and 84 have been allocated a high Landscape Significance and a Retention Value of *Priority for Retention*.
- 3.7.2 The supplied plans show that demolition works, construction of a new retail building and footpath renewal works are proposed within the TPZ areas of Trees 80, 81 and 84. The extent of works represents *Major Encroachments* as defined by AS-4970. Clause 3.3.4 of AS-4970 notes that design factors and tree sensitive methods can be used to minimise the impact of the encroachment.
- 3.7.3 Pruning of Trees 80, 81 and 84 will be required to accommodate the new building. Due to the trees' crown form with limited lateral branching, the removal of a number of large diameter first and second order branches will be required. Tree 80 has a reduced crown density indicating the tree may be subject to a degree of physiological stress. Particularly for this tree, the extent of pruning works proposed may impact tree vigour and potentially reduce its Useful Life Expectancy. The pruning will also impact the trees' crown form and symmetry although this will be less evident when the trees are viewed from within the street. Refer to Pruning Specification (Section 3.13).

3.7.4 Recommendations

The following methods are recommended within the TPZ areas of Trees 80, 81 and 84 to minimise adverse impacts:

- Demolition of existing structures and pavements should be undertaken using tree sensitive methods. Where possible, existing underground structures should be left in-situ. Where tree roots are in contact with, or have grown under existing kerb sections or footings within SRZ areas, the kerb/footing should remain in situ and be assessed by the Project Arborist to determine if they are potentially providing support to the trees' root systems.
- The colonnade area and pathway adjacent to Trees 80 and 81 should be an elevated structure supported on isolated piered footings (with all other parts of the structure positioned above existing ground levels). Pier hole locations should be flexible to enable the retention of roots (>25mmØ, or as deemed necessary by the Project Arborist). The pier diameters should be kept as small as possible to enable positioning between tree roots with minimal root pruning. No fill should be installed beneath the elevated structure to maintain adequate gaseous exchange through profile. Excavation for the pier holes should be undertaken using tree sensitive methods (hand/hydrovac/airspade etc).

An irrigation system with soil moisture monitors should be installed in the void beneath the elevated pathway to ensure ongoing and adequate water supply to the trees.

- New pavements (including sub-base materials) should be installed above or at existing grade and utilize existing sub-base layers where possible. Surfaces and sub-base materials should be thinned as required above roots (with appropriate root protection installed). The design and levels of pavements/kerbs should be modified to enable the retention of roots (>25mmØ, or as deemed necessary by the Project Arborist).
- Plant installation should be undertaken using hand tools and roots (>25mmØ) should be retained and protected. No mechanical cultivation/ripping of soils should be undertaken.

3.8 Tree 82

- 3.8.1 Tree 82 has been identified as *Corymbia citriodora* (Lemon Scented Gum) and is located within the southern road reserve of Smidmore Street. Tree 82 has been allocated a high Landscape Significance and a Retention Value of *Priority for Retention*.
- 3.8.2 The supplied plans show Tree 82 is proposed for removal to accommodate the elevated pedestrian connection. The pedestrian connection runs through eastern side of the tree's crown and the extent of pruning required to accommodate the structure would require the removal of more than 50% of its total crown volume.

3.9 Tree 88

- 3.9.1 Tree 88 has been identified as *Corymbia citriodora* (Lemon Scented Gum) and is located at the western end of the site, near the junction of Smidmore Street and Edinburgh Road. Tree 88 has been allocated a moderate Landscape Significance and a Retention Value of *Consider for Retention*.
- 3.9.2 The supplied plans show Tree 88 is proposed for removal to accommodate the new building footprint. Tree 88 is an early-mature specimen growing at the junction of two existing masonry walls. The tree is partially suppressed by the larger adjacent trees. Replacement planting using healthy, advanced-size specimens could replace the loss of amenity within a short to medium timeframe.

3.10 Trees 89, 90, 92, 94, 95, 98 & 100-104

- 3.10.1 Trees 89, 90, 92, 95, 98 and 100-104 are a mixed species planting including *Acmena smithii* 'Minor' (Lillypilly), *Syzygium paniculatum* (Lillypilly), *Leptospermum petersonii* (Lemon Scented Teatree), *Pistacia chinensis* (Chinese Pistachio) and *Callistemon viminalis* (Weeping Bottlebrush), and are located within the Edinburgh Road road reserve. Tree 94 *Elaeocarpus reticulatus* (Blueberry Ash) has recently died (as indicated by the dead foliage currently present within its crown). These trees have been allocated a low Landscape Significance and a Retention Value of *Consider for Removal*.
- 3.10.2 The supplied plans show Trees 89, 90, 92, 94, 95, 98 and 100-104 are proposed for removal as part of the landscape treatment. Their removal should have a low visual impact due to their relatively small size and location. Replacement planting using healthy, advanced-size specimens could replace the loss of amenity within a short timeframe.

3.11 Trees 93 & 97

- 3.11.1 Trees 93 and 97 have been identified as *Melaleuca quinquenervia* (Broad-leafed Paperbark) and are located within the Edinburgh Road road reserve. The trees have been allocated a moderate Landscape Significance and a Retention Value of *Consider for Retention*.

- 3.11.2 The supplied plans show Trees 93 and 97 are proposed for removal as part of the landscape treatment. The trees have developed a poor and asymmetrical crown form as a result of repeat line clearance works. A high volume of epicormic growth is also present at the lopping points. Epicormic growth can have an increased failure potential, particularly in storms and strong winds.

3.12 105-108

- 3.12.1 Trees 105-108 have been identified as *Livistona australis* (Cabbage Tree Palm) and are located within the Edinburgh Road road reserve. The trees have been allocated a moderate Landscape Significance and a Retention Value of *Consider for Retention*.

- 3.12.2 The supplied plans show Trees 105-108 are proposed for transplanting to an unspecified location. *Livistona australis* (Cabbage Tree Palm) are arborescent monocots and are generally tolerant of transplanting, even when of a large mature size. A tree transplanting contractor should be engaged to advise on the rootball preparation, transplanting and aftercare methods required to ensure successful relocation of these trees.

3.13 Pruning Specification

- 3.13.1 The supplied plans show that Trees 75-78, 80, 81 and 84 will need to be pruned to provide clearance to the new building as outlined within Table 1-7 below.

3.13.2 Table 1: Tree 75

Branch Orientation	Order of Branch	Branch Diameter	Height Above Grade	Comments	Plate No.
SE	1 st	300mm	6.5m	2 x branches	7
	Higher order	<50mm		Selectively reduce to suitable small diameter lateral branches	

3.13.3 Table 2: Tree 76

Branch Orientation	Order of Branch	Branch Diameter	Height Above Grade	Comments	Plate No.
SE	1 st	275mm	6m		8
SE	1 st	250mm	10m		8
	Higher order	<50mm		Selectively reduce to suitable small diameter lateral branches	

3.13.4 Table 3: Tree 77

Branch Orientation	Order of Branch	Branch Diameter	Height Above Grade	Comments	Plate No.
S	2 nd	200mm	6m	2 x branches	9
SE	3 rd	100mm	7m		9
	Higher order	<50mm		Selectively reduce to suitable small diameter lateral branches	

3.13.5 Table 4: Tree 78

Branch Orientation	Order of Branch	Branch Diameter	Height Above Grade	Comments	Plate No.
	1 st	250mm	6m		10
	1 st	125mm	8m		10
	1 st	125mm	10m		10
	Higher order	<50mm		Selectively reduce to suitable small diameter lateral branches	

3.13.6 Table 5: Tree 80

Branch Orientation	Order of Branch	Branch Diameter	Height Above Grade	Comments	Plate No.
S	1 st	200mm	6.5m		11
SW	3 rd	100mm	6.5		11
S	1 st	125mm	7m		11
SE	1 st	100mm	8.5m		11
S	1 st	125mm	9m		11
	Higher order	<50mm		Selectively reduce to suitable small diameter lateral branches	

3.13.7 Table 6: Tree 81

Branch Orientation	Order of Branch	Branch Diameter	Height Above Grade	Comments	Plate No.
SW	2 nd	200mm	8m	Selectively reduce to 2 nd order lateral branches	13
SE	3 rd	75mm	8.5m		12
S	2 nd	75mm	10m		12
SW	1 st	125mm	12m		12
S	1 st	150mm	12m		12
	Higher order	<50mm		Selectively reduce to suitable small diameter lateral branches	

3.13.8 Table 7: Tree 84

Branch Orientation	Order of Branch	Branch Diameter	Height Above Grade	Comments	Plate No.
S	2 nd	200mm	9m	Selectively reduce to 2 nd order lateral branch	14
S	1 st	250mm	10m		14
	Higher order	>75mm		Selectively reduce to suitable small diameter lateral branches	

3.13.9 The assessment of the pruning requirements detailed in this Report was estimated from ground level only. Provision should be made within the design so that additional pruning for construction access and scaffolding/hoarding is not required. Where additional clearance is required, branches may be temporarily pushed or tied. Where branches cannot be pushed or tied back without damage, scaffolding/hoarding should be modified and constructed around branches (with appropriate branch protection installed as required).

3.13.10 Pruning works should be carried out by a Practising Arborist. The Practising Arborist should hold a minimum qualification equivalent (using the Australian Qualifications Framework) of Level 3 or above, in Arboriculture or its recognised equivalent. The Practising Arborist should have a minimum of 3 years' experience in practical Arboriculture. Pruning work should be undertaken in accordance with *Australian Standard 4373: Pruning of Amenity Trees (2007)*, *Safe Work Australia Guide for Managing Risks of Tree Trimming and Removal Work (2016)* and other applicable legislation and codes.

3.14 Replacement Planting

3.14.1 The supplied plans show replacement street trees are proposed along Edinburgh Road and Murray Street. The trees should be supplied as advanced-size stock to help offset the loss of amenity resultant from the tree removals.

3.14.2 Replacement planting should be supplied/installed in accordance with the *Marrickville Street Tree Masterplan (2014)* and *Australian Standard 2303 (2015) Tree Stock for Landscape Use*.

4.0 CONCLUSION

4.1 Forty one (41) trees were assessed in preparation of this Report, and consist of a mix of locally indigenous, Australian native and exotic species. With the exception of Trees 65-74 and 88, all of the trees are located within the road reserve areas and are managed by Inner West Council.

4.2 The proposal is for a Section 75W Application for the Marrickville Metro Shopping Centre Redevelopment. The supplied plans show the proposed works in the vicinity of the existing trees include the demolition of existing structures and pavements, construction of a new retail building and installation of landscape treatments along the road reserve areas.

4.3 The supplied plans show that sixteen (16) trees (Trees 79, 82, 83, 88-90, 92-95, 97, 98 & 100-104) are to be removed to accommodate the proposed development. Of these, one (1) tree has been allocated a Retention Value of *Priority for Retention*, five (5) trees have been allocated a Retention Value of *Consider for Retention*, and ten (10) trees have been allocated a Retention Value of *Consider for Removal*. Tree 94 is dead.

4.4 The supplied plans show twenty (20) trees (Trees 62-78, 80, 81 & 84) are to be retained as part of the proposed development. Of these, works are proposed within the TPZ areas of Trees 65, 66, 67, 69, 75, 76, 77, 78, 80, 81 and 84. Tree sensitive design, demolition and construction methods should be used to minimise adverse impacts (refer to Section 3.0). The trees should be protected in accordance with the Tree Protection Specification (**Appendix 5**).

4.5 The supplied plans show that Trees 75-78, 80, 81 and 84 will need to be pruned to provide clearance to the new building. Trees 76-78 and 80 have a reduced crown densities indicating the trees may be subject to a degree of physiological stress. Particularly for these trees, the extent of pruning works proposed may impact tree vigour and potentially reduce their Useful Life Expectancies. The pruning will also impact the trees' crown form and symmetry although this will be less evident when the trees are viewed from within the street. Pruning work should be undertaken in accordance with *Australian Standard 4373: Pruning of Amenity Trees (2007)*, *Safe Work Australia Guide for Managing Risks of Tree Trimming and Removal Work (2016)* and other applicable legislation and codes.

- 4.6 The supplied plans show that four (4) trees (Trees 105-108) are proposed for transplanting to an unspecified location. *Livistona australis* (Cabbage Tree Palm) are arborescent monocots and are generally tolerant of transplanting, even when of a large mature size. A tree transplanting contractor should be engaged to advise on the rootball preparation, transplanting and aftercare methods required to ensure successful relocation of these trees.
- 4.7 The supplied plans show replacement street trees are to be installed along Edinburgh Road and Murray Street. The trees should be supplied as advanced-size stock to help offset the loss of amenity resultant from the tree removals. Replacement planting should be supplied/installed in accordance with the *Marrickville Street Tree Masterplan (2014)* and *Australian Standard 2303 (2015) Tree Stock for Landscape Use*.

5.0 LIMITATIONS & DISCLAIMER

TreeiQ takes care to obtain information from reliable sources. However, TreeiQ can neither guarantee nor be responsible for the accuracy of information provided by others. Plans, diagrams, graphs and photographs in this Arboricultural Report are visual aids only and are not necessarily to scale. This Report provides recommendations relating to tree management only. Advice should be sought from appropriately qualified consultants regarding design/construction/ecological/heritage etc issues.

This Report has been prepared for exclusive use by the client. This Report shall not be used by others or for any other reason outside its intended target or without the prior written consent of TreeiQ. Unauthorised alteration or separate use of any section of the Report invalidates the Report.

Many factors may contribute to tree failure and cannot always be predicted. TreeiQ takes care to accurately assess tree health and structural condition. However, a tree's internal structural condition may not always correlate to visible external indicators. There is no warranty or guarantee, expressed or implied that problems or deficiencies regarding the trees or site may not arise in the future. Information contained in this report covers only the trees assessed and reflects the condition of the trees at the time of inspection. Additional information regarding the methodology used in the preparation of this Report is attached as Appendix 1. A comprehensive tree risk assessment and management plan for the trees is beyond the scope of this Report.

Reference should be made to any relevant legislation including Tree Management Controls. All recommendations contained within this Report are subject to approval from the relevant Consent Authority.

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- Office of Environment and Heritage (2011), *BioNet Atlas of NSW Wildlife*
- Standards Australia (2009), *Protection of Trees on Development Sites AS-4970*
- Standards Australia (2007), *Pruning of Amenity Trees AS-4373*
- Standards Australia (2015), *Tree Stock for Landscape Use AS-2303*

Appendix 1: Methodology

- 1.1 Site Inspection:** This report was determined as a result of a comprehensive site during September 2017. The comments and recommendations in this report are based on findings from this site inspection.
- 1.2 Visual Tree Assessment (VTA):** The subject tree(s) was assessed using the Visual Tree Assessment criteria and notes as described in *The Body Language of Trees – A Handbook for Failure Analysis*.⁵ The inspection was limited to a visual examination of the subject tree(s) from ground level only. No internal diagnostic testing was undertaken as part of this assessment. Trees outside the subject site were assessed from the property boundaries only.
- 1.3 Tree Dimensions:** The dimensions of the subject tree(s) are approximate only.
- 1.4 Tree Locations:** The location of the subject tree(s) was determined from the supplied plans.
- 1.5 Trees & Development:** Tree Protection Zones, Tree Protection Measures and Sensitive Construction Methods for the subject tree were based on methods outlined in *Australian Standard 4970-2009 Protection of Trees on Development Sites*.

The *Tree Protection Zone* (TPZ) is described in AS-4970 as a combination of the root area and crown area requiring protection. It is an area isolated from construction disturbance, so that the tree remains viable.

The *Structural Root Zone* (SRZ) is described in AS-4970 as the area around the base of a tree required for the tree's stability in the ground. Severance of structural roots within the SRZ is not recommended as it may lead to the destabilisation and/or demise of the tree.

In some cases it may be possible to encroach into or make variations to the theoretical TPZ. A *Minor Encroachment* is less than 10% of the area of the TPZ and is outside the SRZ. The area lost to this encroachment should be compensated for elsewhere and contiguous with the TPZ. A *Major Encroachment* is greater than 10% of the TPZ or inside the SRZ. In this situation the Project Arborist must demonstrate that the tree would remain viable. This may require root investigation by non-destructive methods or the use of sensitive construction methods.

- 1.6 Tree Health:** The health of the subject tree(s) was determined by assessing:
- I. Foliage size and colour
 - II. Pest and disease infestation
 - III. Extension growth
 - IV. Crown density
 - V. Deadwood size and volume
 - VI. Presence of epicormic growth
- 1.7 Tree Structural Condition:** The structural condition of the subject tree(s) was assessed by:
- I. Assessment of branching structure
(i.e co-dominant/bark inclusions, crossing branches, branch taper, terminal loading, previous branch failures)
 - II. Visible evidence of structural defects or instability
(i.e root plate movement, wounds, decay, cavities, fungal brackets, adaptive growth)
 - III. Evidence of previous pruning or physical damage
(root severance/damage, lopping, flush-cutting, lions tailing, mechanical damage)
- 1.8 Useful Life Expectancy (ULE):** The ULE is an estimate of the longevity of the subject tree(s) in its growing environment. The ULE is modified where necessary to take in consideration tree(s) health, structural condition and site suitability. The tree(s) has been allocated one of the following ULE categories (Modified from Barrell, 2001):
- I. 40 years +
 - II. 15-40 years
 - III. 5-15 years
 - IV. Less than 5 years

⁵ Mattheck & Breloer (2003)

- 1.9 Landscape Significance:** Landscape Significance was determined by assessing the combination of the cultural, environmental and aesthetic values of the subject tree(s). Whilst these values are subjective, a rating of high, moderate, low or insignificant has been allocated to the tree(s). This provides a relative value of the tree's Landscape Significance which may aid in determining its Retention Value. If the tree(s) can be categorized into more than one value, the higher value has been allocated.

Landscape Significance	Description
Very High	The subject tree is listed as a Heritage Item under the <i>Local Environmental Plan</i> with a local or state level of significance.
	The subject tree is listed on Council's Significant Tree Register or is considered to meet the criteria for significance assessment of trees and/or landscapes by a suitably qualified professional. The criteria are based on general principles outlines in the Burra Charter and on criteria from the Register of the National Estate.
	The subject tree is a remnant tree.
High	The subject tree creates a 'sense of place' or is considered 'landmark' tree.
	The subject tree is of local, cultural or historical importance or is widely known.
	The subject tree has been identified by a suitably qualified professional as a species scheduled as a Threatened or Vulnerable Species or forms part of an Endangered Ecological Community associated with the subject site, as defined under the provisions of the <i>Threatened Species Conservation Act 1995 (NSW)</i> or the <i>Environmental Protection and Biodiversity Conservation Act 1999</i> .
	The subject tree is known to provide habitat to a threatened species.
	The subject tree is an excellent representative of the species in terms of aesthetic value.
	The subject tree is of significant size, scale or makes a significant contribution to the canopy cover of the locality.
	The subject tree forms part of the curtilage of a heritage item with a known or documented association with that item.
Moderate	The subject tree makes a positive contribution to the visual character or amenity of the area.
	The subject tree provides a specific function such as screening or minimising the scale of a building.
	The subject tree has a known habitat value.
	The subject tree is a good representative of the species in terms of aesthetic value.
Low	The subject tree is an environmental pest species or is exempt under the provisions of the local Council's Tree Management Controls
	The subject tree makes little or no contribution to the amenity of the locality.
	The subject tree is a poor representative of the species in terms of aesthetic value.
Insignificant	The subject tree is declared a Noxious Weed under the Noxious Weeds Act

- 1.10 Retention Value:** Retention Value was based on the subject tree's Useful Life Expectancy and Landscape Significance. The Retention Value was modified where necessary to take in consideration the subject tree's health, structural condition and site suitability. The subject tree(s) has been allocated one of the following Retention Values:

- I. Priority for Retention
- II. Consider for Retention
- III. Consider for Removal
- IV. Priority for Removal


ULE		Landscape Significance			
	Very High	High	Moderate	Low	Insignificant
40 years +	Priority for Retention	Priority for Retention		Consider for Removal	Priority for Removal
15-40 years		Priority for Retention	Consider for Retention		
5-15 years		Consider for Retention			
Less than 5 years	Consider for Removal	Priority for Removal			

The above table has been modified from the Footprint Green Tree Significance and Retention Value Matrix.

Marrickville Metro Expansion

34 Victoria Road, Marrickville, NSW 2204

- 000 Coversheet
- 002 Landscape Character Plan
- 010 Tree Removal Plan
- 100 Landscape Masterplan
- 101 Landscape Plan
- 102 Landscape Plan

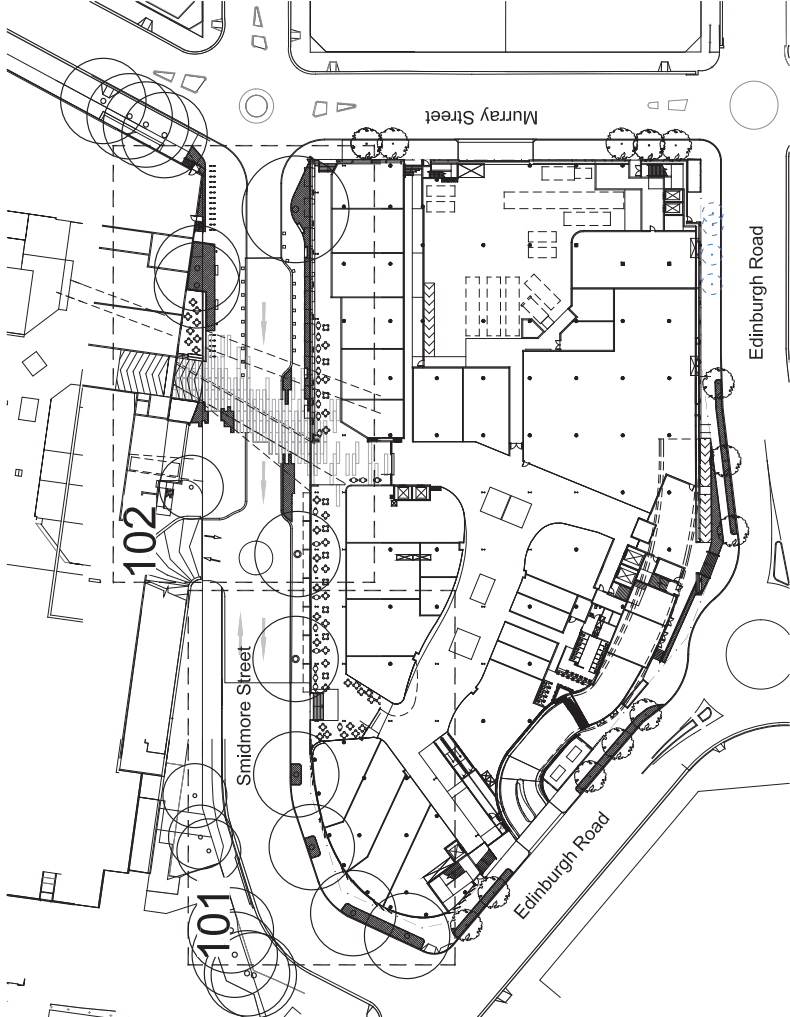

NOT FOR CONSTRUCTION

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The contractor shall check and verify all work on site including work by others) before commencing the landscape installation. Any discrepancies are to be reported to the Landscape Architect for confirmation. Any material dimensions not shown shall be referred to the Landscape Architect for confirmation.

Revision		Author	Check	Date
B	Approved	Coordination		
	A	For Comment		

Drawn: NM
Check: NM
Date: 22.09.2017

LEGEND

Key files:

S I T E I M A G E



Project:
Marrickville Metro Shopping
Centre Redevelopment
34 Victoria Rd, Marrickville NSW

Client:
AMP CAPITAL
Level 1, 101-103, 105-107, 109-111, 537-539, 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Shareway Pedestrian Connection



Street Tree Planting B Murray Street *Eleocharpus eumundi*
C Edinburgh Road *Lagerstroemia indica*



Suspended path around existing trees



Unit paver pedestrian connection



Paved shareway



Seating



Bike Racks




Dog Parking



Massed planting



Sculptural Bollards to edge of Shareway

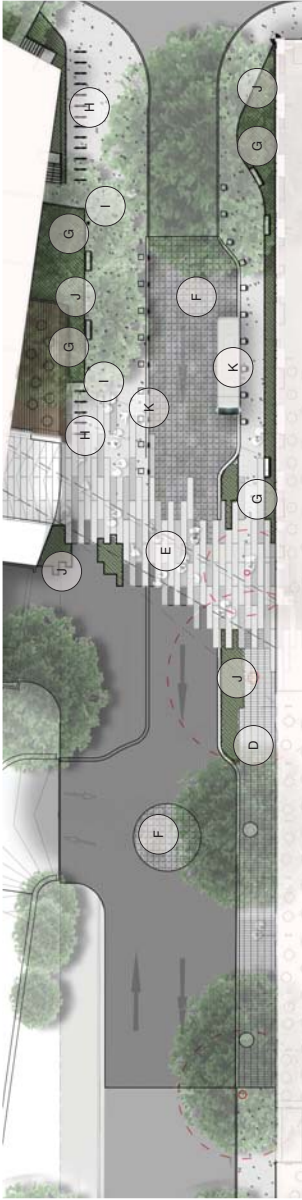

Detail Plan 1 - Smidmore Street

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JD NM 27.09.2017
JD NM 22.09.2017
Drawn Check Date

B Architectural Coordination
A For Comment
Base Revision Description

LEGEND

Key Plan:



S I T E I M A G E



Client: AMP CAPITAL

Project: Marrickville Metro Shopping
Centre Redevelopment
34 Victoria Rd, Marrickville NSW

Scale: 1:500
Job Number: SS16-3593
Drawing Number: 002 B

Drawing Name: Landscape Character Plan

SECTION 75W



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A. For Comment
B. Approved Coordination
Base: Revised Description

JD: NM 22.09.2017
JD: NM 22.09.2017
Drawn: Check Date

- LEGEND
- Existing Tree to be Retained
 - Existing tree to be Removed
 - Existing tree to be transplanted

Note:
To be read in conjunction with Tree ID
architectural report

Key Plan

SITE IMAGE

LANDSCAPE ARCHITECTS
Level 1, 100 Regent Street
Sydney NSW 2000
T: +61 2 9332 5500
F: +61 2 9332 5501
www.siteimage.com.au

Project
Murrumbidgee Metro Shopping
Centre Redevelopment
34 Victoria Rd, Murrumbidgee NSW

AMPCAPITAL

Drawing Name: Landscape Existing Tree Plan

SECTION 75W

Scale: 1:250 @ A1

Job Number: SS16-3593

010 B



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Issue	Revision	Description
B	Architectural Contributions	
A	For Comment	
JD	MM	27.03.2017
JD	MM	22.03.2017
Drawn	Check	Date


LEGEND	Property Boundary	Concrete	Asphalt
	Existing Tree to be retained	Unit Pavers	Massed Planting Refer indicative Plant Schedule
	Existing Tree to be removed	Textured trafficable unit pavers	

Key Plan

SITE IMAGE

Client: AMP CAPITAL
Project: Marrickville Metro Shopping Centre Redevelopment
34 Victoria Rd, Marrickville NSW
Drawing Number: SS16-3593
Scale: 1:250 @ A1
SECTION 75W

Drawing Name: Landscape Masterplan
Drawing Number: SS16-3593
Scale: 1:250 @ A1
SECTION 75W
100 B

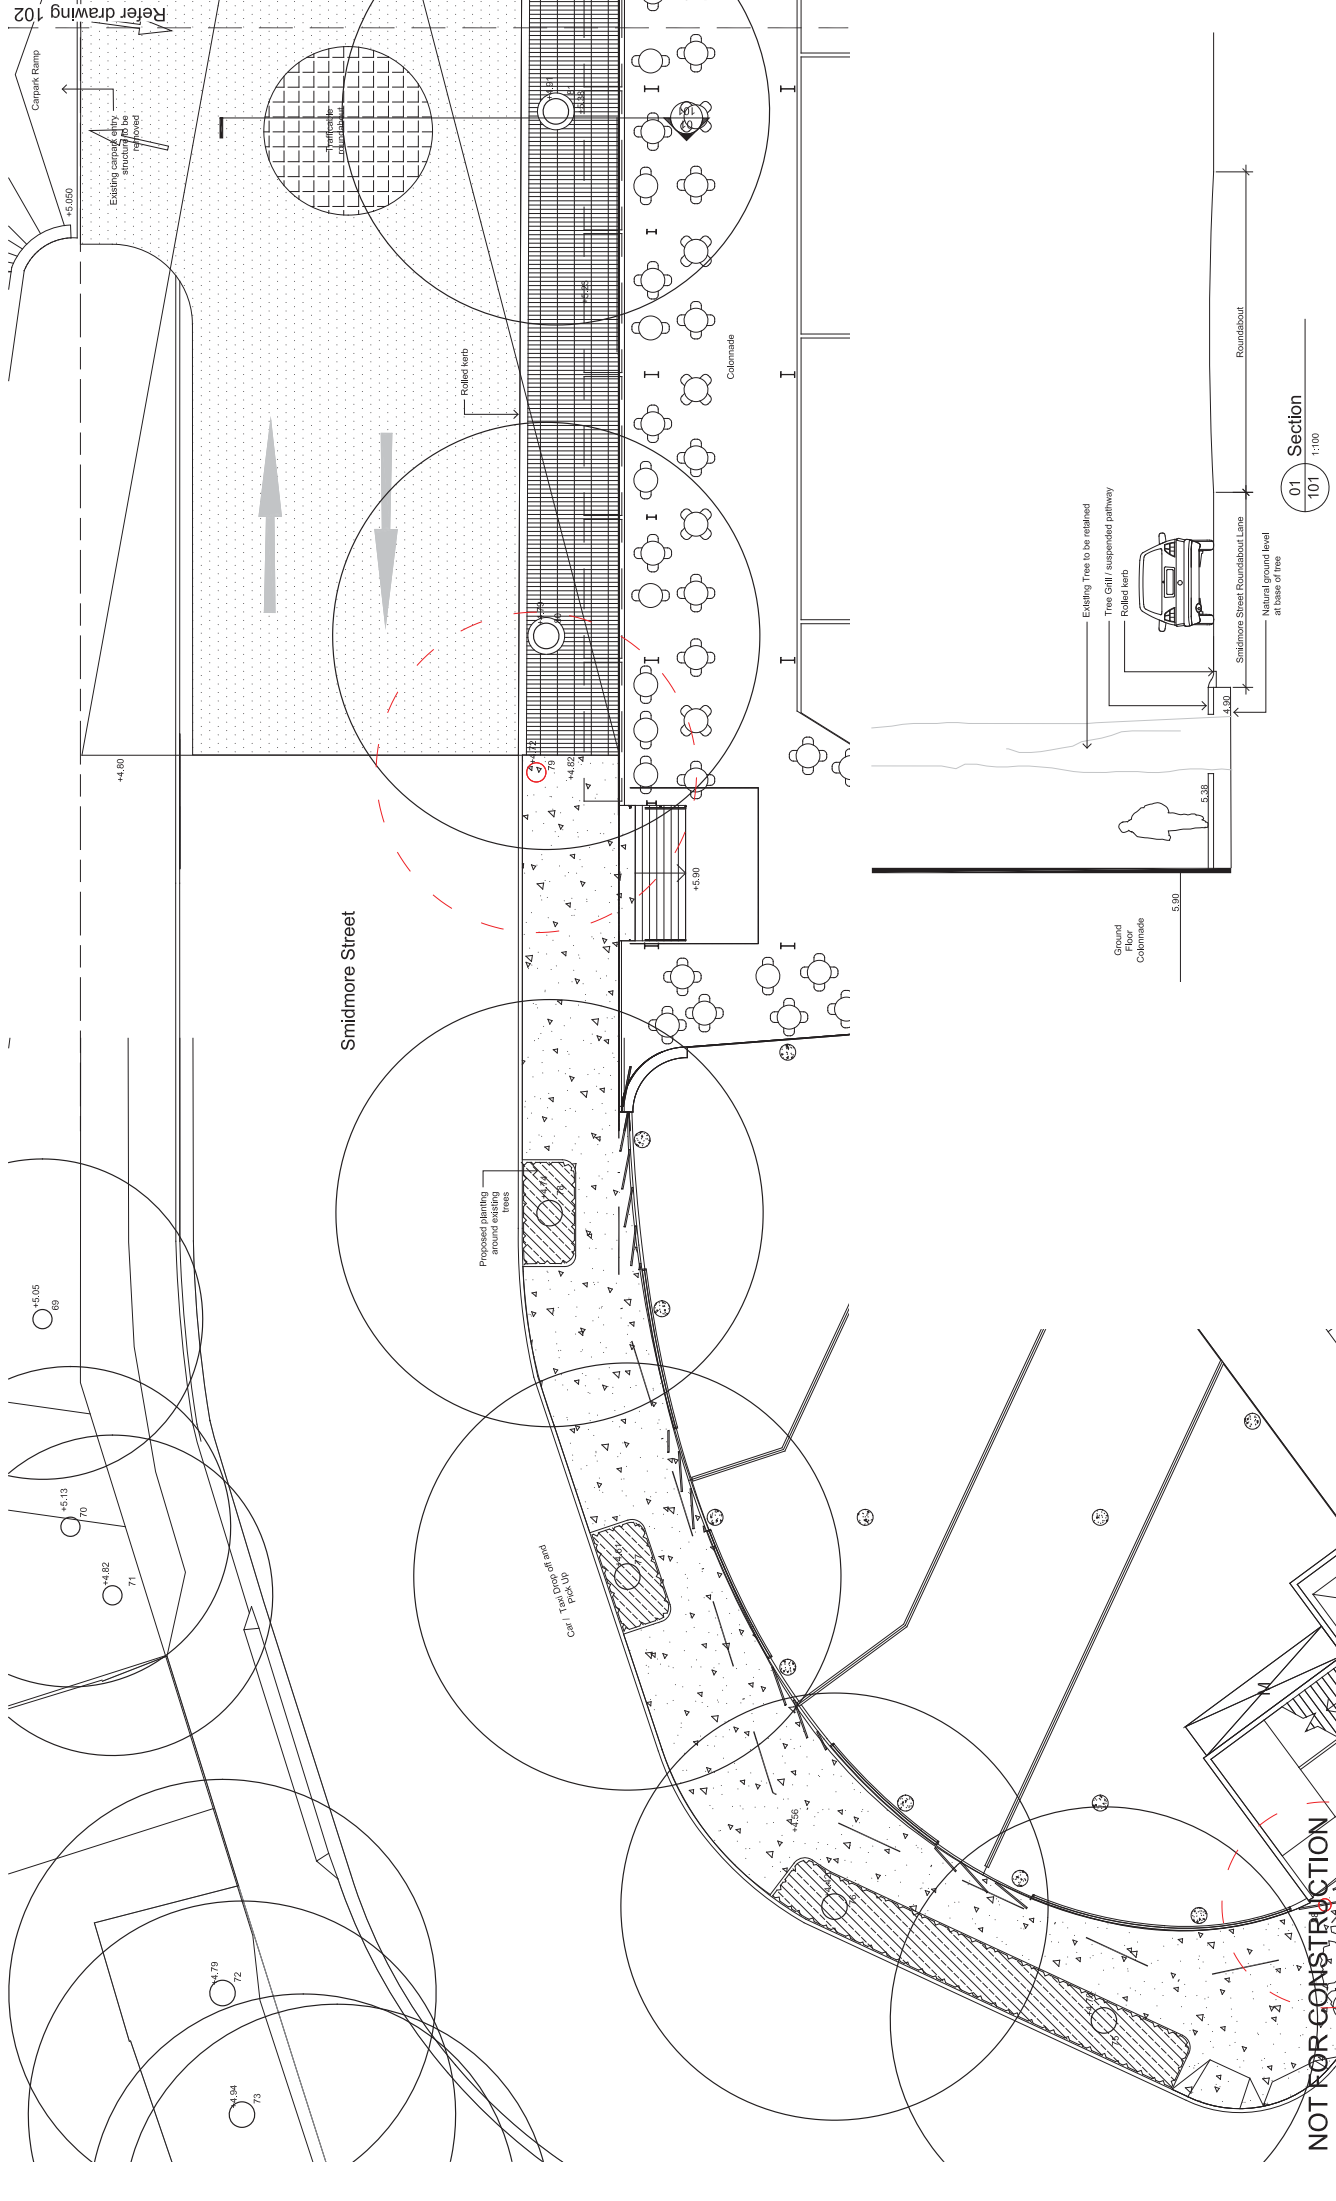

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LEGEND

Property Boundary

Existing Tree to be retained

Existing Tree to be removed

Asphalt

Concrete

Unit Pavers

Textured trafficable unit pavers

Massed Planting

Schedule

Refer Indicative Plant Schedule

removed

Key Plan

101

SITE IMAGE

CLINT

LANDSCAPE ARCHITECTS

Level 1, 54 Eagle Street

Perth, Western Australia

Tel: 08 9332 5500

www.siteimage.com.au

PROJECT

Marrickville Metro Shopping Centre Redevelopment

34 Victoria Rd, Marrickville NSW

DRAWING NAME

Landscape Plan

SECTION 75W

Scale: 1:100 @ A1


Job Number: SS16-3593

101 B

Drawing Number

101

101

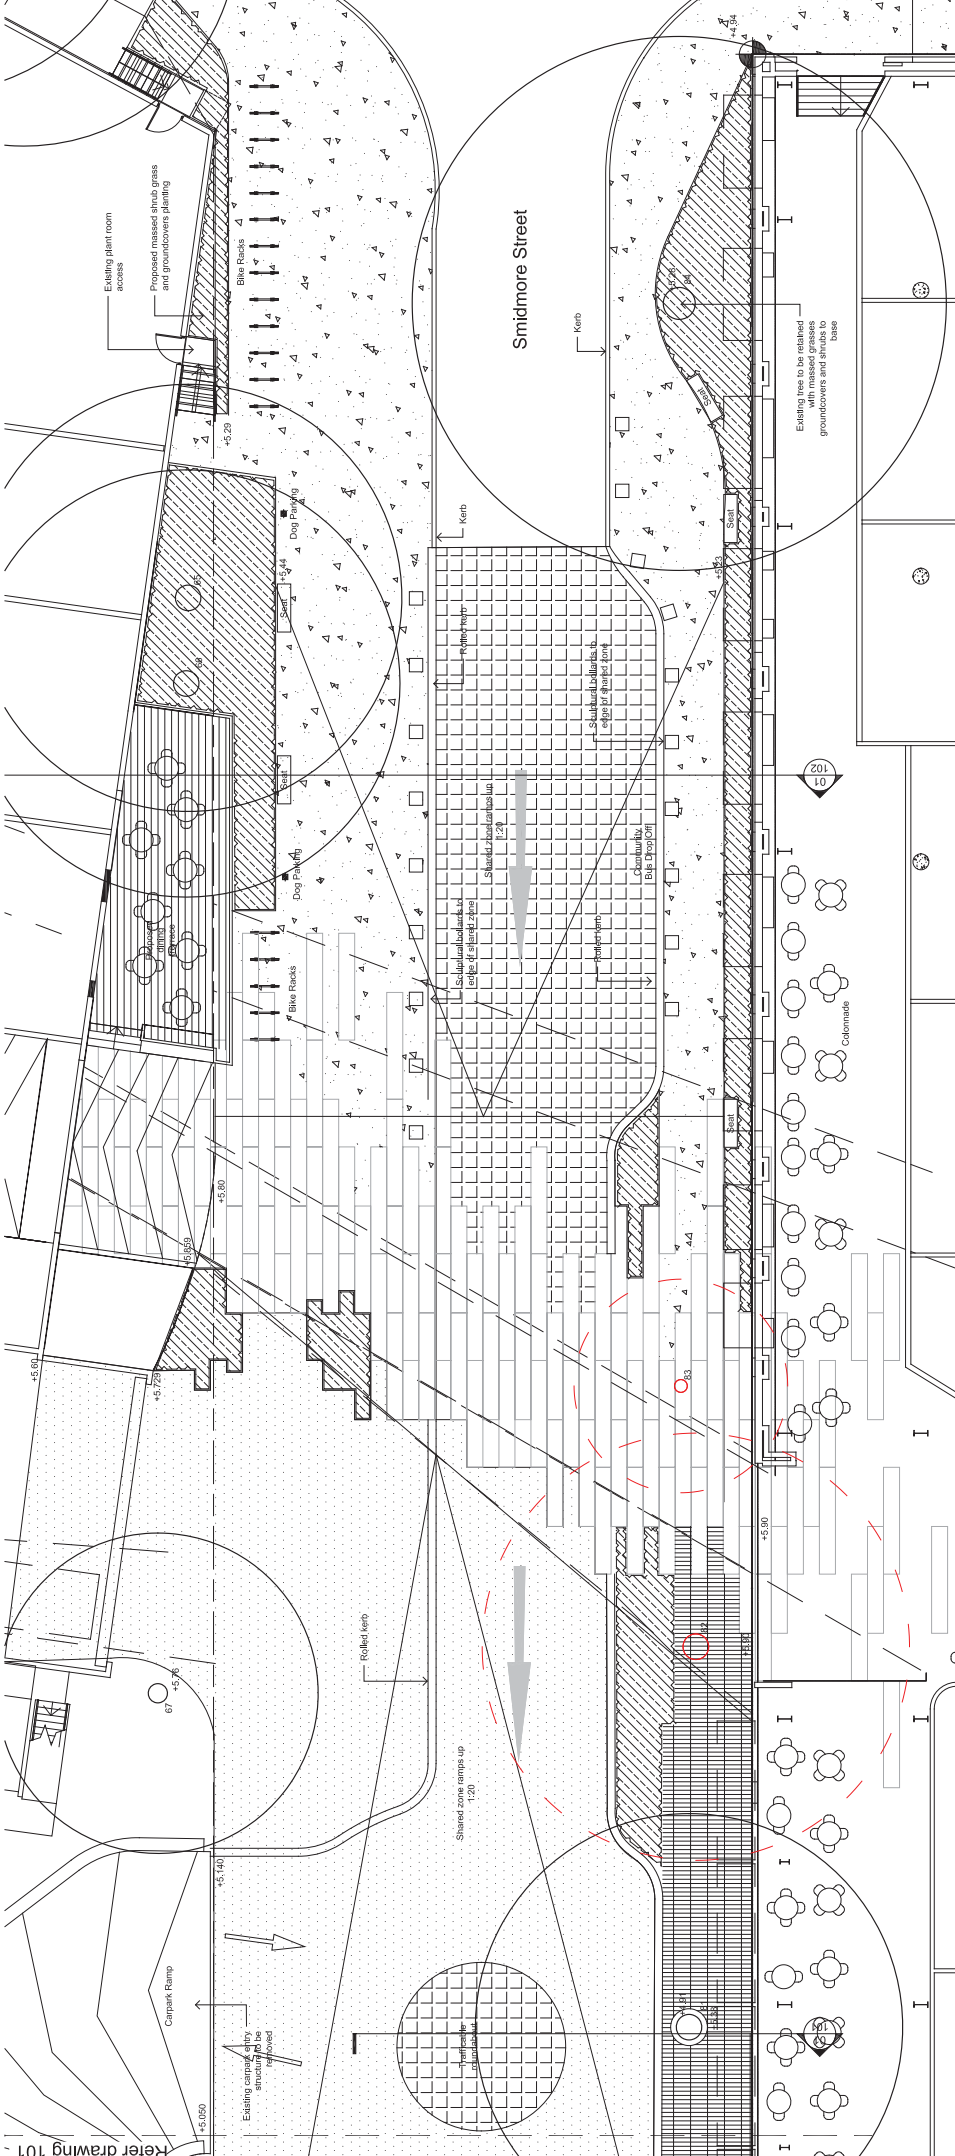



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Drawn: Check Date: 22.09.2017
Reviewed: For Comment Date: 22.09.2017
Approved: For Comment Date: 22.09.2017

LEGEND	Property Boundary	Concrete	Asphalt
	Existing Tree to be related	Unit Pavers	Massed Planting
	Existing Tree to be removed	Textured trafficable unit pavers	Refer Indicative Plant Schedule



SITE IMAGE
Landscape Architects
Level 1, 101-103, 104-105, 106-107, 108-109, 320-321, 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2264-2265, 2266-2267, 2268-2269, 2270-2271, 2272-2273, 2274-2275, 2276-2277, 2278-2279, 2280-2281, 2282-2283, 2284-2285, 2286-2287, 2288-2289, 2290-2291, 2292-2293, 2294-2295, 2296-2297, 2298-2299, 2300-2301, 2302-2303, 2304-2305, 2306-2307, 2308-2309, 2310-2311, 2312-2313, 2314-2315, 2316-2317, 2318-2319, 2320-2321, 2322-2323, 2324-2325, 2326-2327, 2328-2329, 2330-2331, 2332-2333, 2334-2335, 2336-2337, 2338-2339, 2340-2341, 2342-2343, 2344-2345, 2346-2347, 2348-2349, 2350-2351, 2352-2353, 2354-2355, 2356-2357, 2358-2359, 2360-2361, 2362-2363, 2364

Appendix 3: Tree Assessment Schedule

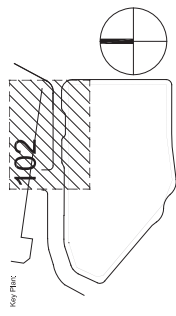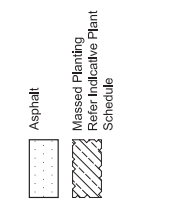Tree No.	Species	DBH (mm)	Height (m)	Radial Crown Spread (m)	Health Rating	Structural Condition Rating	Comments	ULE (years)	L/Significance	Retention Value	Radial TPZ (m)	Radial SRZ (m)	Implication
62	<i>Ficus microcarpa</i> var. 'Hillii' (Hills Weeping Fig)	550	13	5	Good	Poor	Wound/s with advanced stages of decay. Branch inclusions. Trunk cavity, minor.	5-15	Moderate	Consider for Retention	6.6	2.6	Retain. No works within TPZ.
63	<i>Ficus microcarpa</i> var. 'Hillii' (Hills Weeping Fig)	850	17	10	Good	Fair	Wound/s with early stages of decay. Branch inclusions.	5-15	High	Consider for Retention	10.2	3.1	Retain. No works within TPZ.
64	<i>Ficus microcarpa</i> var. 'Hillii' (Hills Weeping Fig)	950	17	9	Good	Fair	Wound/s with early stages of decay. Branch inclusions. Failed lower branch, presumed resulting from high sided vehicle impact.	5-15	High	Consider for Retention	11.4	3.3	Retain. No works within TPZ.
65	<i>Ficus microcarpa</i> var. 'Hillii' (Hills Weeping Fig)	350 300 600	18	9	Good	Fair	Structures with SRZ. Branch inclusion/s. Wound/s with advanced stages of decay. Branch contact with steel cage.	5-15	High	Consider for Retention	9.1	3	Retain. Major encroachment, landscape works.
66	<i>Ficus microcarpa</i> var. 'Hillii' (Hills Weeping Fig)	400 450 300	18	12	Good	Fair	Co-dominant inclusion. Wound, advanced stages of decay.	5-15	High	Consider for Retention	8.2	2.9	Retain. Major encroachment, landscape works.
67	<i>Ficus microcarpa</i> var. 'Hillii' (Hills Weeping Fig)	400 400 400 300	16	9	Good	Fair	Branch inclusion/s. Wound/s with early stages of decay. Exposed surface roots.	5-15	High	Consider for Retention	9.1	3	Retain. Major encroachment, landscape works.
68	<i>Acacia floribunda</i> (White Sally Wattie)	200 200 + 200	7 max	5 max	Fair	Fair	Group of 2. Crown density 50-75%. Wound/s with early stages of decay.	<5	Low	Priority for Removal	3.6	2	Retain. No works within TPZ.
69	<i>Ficus microcarpa</i> var. 'Hillii' (Hills Weeping Fig)	1000	18	9	Good	Good	Wound/s with early stages of decay. Low volumes of small diameter (<25mm) epicormic growth.	5-15	High	Consider for Retention	12	3.4	Retain. No works within TPZ.

Tree No.	Species	DBH (mm)	Height (m)	Radial Crown Spread (m)	Health Rating	Structural Condition Rating	Comments	ULE (years)	L/Significance	Retention Value	Radial TPZ (m)	Radial SRZ (m)	Implication
70	<i>Ficus microcarpa</i> var. 'Hillii' (Hills Weeping Fig)	800 600	19	8	Good	Fair	Codominant inclusion. Wound/s with early stages of decay. Low volumes of small diameter (<25mm) epicormic growth. Mechanical damage to exposed surface roots.	5-15	High	Consider for Retention	12	3.4	Retain. No works within TPZ.
71	<i>Ficus microcarpa</i> var. 'Hillii' (Hills Weeping Fig)	600 450	19	10	Good	Fair	Codominant inclusion. Wound/s with early stages of decay. Low volumes of small diameter (<25mm) epicormic growth.	5-15	High	Consider for Retention	9	3	Retain. No works within TPZ.
72	<i>Ficus microcarpa</i> var. 'Hillii' (Hills Weeping Fig)	400 300x2 250x2 150	18	8	Good	Good	Wound/s with early stages of decay. Low volumes of small diameter (<25mm) epicormic growth.	5-15	High	Consider for Retention	8.4	2.9	Retain. No works within TPZ.
73	<i>Ficus microcarpa</i> var. 'Hillii' (Hills Weeping Fig)	600 450 400 200	18	6	Good	Fair	Codominant inclusion. Wound/s with early stages of decay. Low volumes of small diameter (<25mm) epicormic growth.	5-15	High	Consider for Retention	9.6	3.1	Retain. No works within TPZ.
74	<i>Ficus microcarpa</i> var. 'Hillii' (Hills Weeping Fig)	1000 900x2 750	18	11	Good	Fair	Codominant inclusion. Wound/s with early stages of decay. Low volumes of small diameter (<25mm) epicormic growth.	5-15	High	Consider for Retention	15	4.3	Retain. No works within TPZ.
75	<i>Corymbia citriodora</i> (Lemon Scented Gum)	650	16	9	Good	Good	Low volumes of medium (25-75mm) diameter deadwood. Girdled roots. Existing structures within SRZ.	15-40	High	Priority for Retention	7.8	2.8	Retain. Major encroachment, building & landscape works.
76	<i>Corymbia citriodora</i> (Lemon Scented Gum)	650	16	9	Fair	Good	Crown density 50-75%. Existing structures within SRZ.	5-15	High	Consider for Retention	7.8	2.8	Retain. Major encroachment, building & landscape works.
77	<i>Corymbia citriodora</i> (Lemon Scented Gum)	550	15	7	Fair	Good	Crown density 50-75%. Low volumes of large (75mm+) diameter deadwood. Existing structures within SRZ.	15-40	High	Priority for Retention	6.6	2.6	Retain. Major encroachment, building & landscape works.
78	<i>Corymbia citriodora</i> (Lemon Scented Gum)	650	17	8	Fair	Good	Hanger. Crown density 50-75%. Existing structures within SRZ.	5-15	High	Consider for Retention	7.8	2.8	Retain. Major encroachment, building & landscape

Tree No.	Species	DBH (mm)	Height (m)	Radial Crown Spread (m)	Health Rating	Structural Condition Rating	Comments	ULE (years)	L/Significance	Retention Value	Radial TPZ (m)	Radial SRZ (m)	Implication
													works.
79	<i>Eucalyptus nicholii</i> (Narrow Leaf Peppermint)	400 400	9	7	Fair	Fair	Crown density 75-95%. Low volumes of medium diameter (25-75mm) deadwood. Low volumes of small diameter (<25mm) epicormic growth. Wound/s, various stages of decay. Existing structures within SRZ. Impact damage to branches.	5-15	Moderate	Consider for Retention	6.8	2.7	Remove. Landscape treatment.
80	<i>Corymbia citriodora</i> (Lemon Scented Gum)	550	15	7	Fair	Good	Low volumes of medium (25-75mm) diameter deadwood. Crown density 50-75%. Girdled roots. Existing structures within SRZ. Mechanical damage to exposed surface roots.	5-15	High	Consider for Retention	6.6	2.6	Retain. Major encroachment, building & landscape works.
81	<i>Corymbia citriodora</i> (Lemon Scented Gum)	650	20	12	Fair	Good	Crown density 75-95%. Low volumes of medium (25-75mm) diameter deadwood. Existing structures within SRZ.	15-40	High	Priority for Retention	7.8	2.8	Retain. Major encroachment, building & landscape works.
82	<i>Corymbia citriodora</i> (Lemon Scented Gum)	1100	20	8	Fair	Good	Crown density 75-95%. Low volumes of medium (25-75mm) diameter deadwood. Structures within SRZ.	15-40	High	Priority for Retention	13.2	3.5	Remove. Landscape treatment.
83	<i>Eucalyptus nicholii</i> (Narrow Leaf Peppermint)	300 450	9	8	Fair	Good	Crown density 25-50%. Moderate volumes of small diameter (<25mm) deadwood. Moderate volumes of small diameter (<25mm) epicormic growth. Partially suppressed. Existing structures within SRZ.	5-15	Moderate	Consider for Retention	6.6	2.6	Remove. Landscape treatment.
84	<i>Corymbia citriodora</i> (Lemon Scented Gum)	850	20	12	Good	Good	Low volumes of medium diameter (25-50mm) deadwood. Crown density 75-95%. Structures within SRZ.	15-40	High	Priority for Retention	10.2	3.1	Retain. Major encroachment, building & landscape works.
88	<i>Corymbia citriodora</i> (Lemon Scented Gum)	300	8	7	Good	Good	Retaining wall within SRZ. Partially suppressed. Asymmetrical crown form.	5-15	Moderate	Consider for Retention	3.6	2	Remove. Building footprint.

Tree No.	Species	DBH (mm)	Height (m)	Radial Crown Spread (m)	Health Rating	Structural Condition Rating	Comments	ULE (years)	L/Significance	Retention Value	Radial TPZ (m)	Radial SRZ (m)	Implication
89	<i>Acmena smithii</i> 'Minor' (Lillypilly)	75	3	2	Good	Fair	Under powerlines. Whipper snipper damage. Scale and sooty mould.	5-15	Low	Consider for Removal	2	1.5	Remove. Landscape treatment.
90	<i>Acmena smithii</i> 'Minor' (Lillypilly)	75	3	2	Fair	Good	Under powerlines. Crown density 50-75%.	5-15	Low	Consider for Removal	2	1.5	Remove. Landscape treatment.
92	<i>Syzygium paniculatum</i> (Lillypilly)	100	3	3	Good	Fair	Pruned for powerline clearance.	5-15	Low	Consider for Removal	2	1.5	Remove. Landscape treatment.
93	<i>Melaleuca quinquenervia</i> (Broad-leafed Paperbark)	750	8	7	Good	Poor	Pruned for powerline clearance. High volumes of small diameter (<25mm) epicormic growth. Wound/s, no visible signs of decay. Poor form.	5-15	Moderate	Consider for Retention	9	3	Remove. Landscape treatment.
94	<i>Elaeocarpus reticulatus</i> (Blueberry Ash)						Dead						Remove. Landscape treatment.
95	<i>Leptospermum petersonii</i> (Lemon Scented Teatree)	200	3	2	Good	Fair	Co-dominant stem removed.	5-15	Low	Consider for Removal	2.4	1.7	Remove. Landscape treatment.
97	<i>Melaleuca quinquenervia</i> (Broad-leafed Paperbark)	1100	14	7	Good	Poor	Pruned for powerline clearance. High volumes of small diameter (<25mm) epicormic growth. Wound/s, no visible signs of decay. Poor form. Path/kerb displacement.	5-15	Moderate	Consider for Retention	13.2	3.5	Remove. Landscape treatment.
98	<i>Acmena smithii</i> 'Minor' (Lillypilly)	200 200	5	3	Good	Poor	Wound/s with early stages of decay. Co-dominant inclusion. Recently crown lifted.	5-15	Low	Consider for Removal	3.5	2	Remove. Landscape treatment.
100	<i>Pistacia chinensis</i> (Chinese Pistachio)	100	4	7	Good	Good	Not in full leaf at time of assessment. Low volumes of small diameter (<25mm) deadwood. Recently crown lifted.	15-40	Low	Consider for Removal	2	1.5	Remove. Landscape treatment.

Tree No.	Species	DBH (mm)	Height (m)	Radial Crown Spread (m)	Health Rating	Structural Condition Rating	Comments	ULE (years)	L/Significance	Retention Value	Radial TPZ (m)	Radial SRZ (m)	Implication
101	<i>Callistemon viminalis</i> (Weeping Bottlebrush)	150	4	2	Good	Good	Previous branch failure. Mechanical damage to roots. Moderate volumes of small diameter (<25mm) deadwood. Recently crown lifted.	5-15	Low	Consider for Removal	2	1.5	Remove. Landscape treatment.
102	<i>Acmena smithii</i> 'Minor' (Lillypilly)	200	4	2	Good	Good	Girdling roots. Recently crown lifted.	15-40	Low	Consider for Removal	2.4	1.7	Remove. Landscape treatment.
103	<i>Callistemon viminalis</i> (Weeping Bottlebrush)	100 100	4	2	Good	Fair	Moderate volumes of small diameter (<25mm) deadwood. Mechanical damage to base.	15-40	Low	Consider for Removal	2	1.5	Remove. Landscape treatment.
104	<i>Acmena smithii</i> 'Minor' (Lillypilly)	150	4	2	Good	Good	Recently crown lifted.	15-40	Low	Consider for Removal	2	1.5	Remove. Landscape treatment.
105	<i>Livistona australis</i> (Cabbage Tree Palm)	400	7	3	Good	Good		15-40	Moderate	Consider for Retention	4	n/a	Transplant.
106	<i>Livistona australis</i> (Cabbage Tree Palm)	400	7	3	Good	Good		15-40	Moderate	Consider for Retention	4	n/a	Transplant.
107	<i>Livistona australis</i> (Cabbage Tree Palm)	400	7	3	Good	Good		15-40	Moderate	Consider for Retention	4	n/a	Transplant.
108	<i>Livistona australis</i> (Cabbage Tree Palm)	400	8	3	Good	Good		15-40	Moderate	Consider for Retention	4	n/a	Transplant.

Appendix 4: Plates



Plate 1: Showing Trees 65 & 66



Plate 2: Showing Tree 67



Plate 3: Showing Trees 76-78



Plate 4: Showing Trees 80-84



Plate 5: Showing Trees 93-97

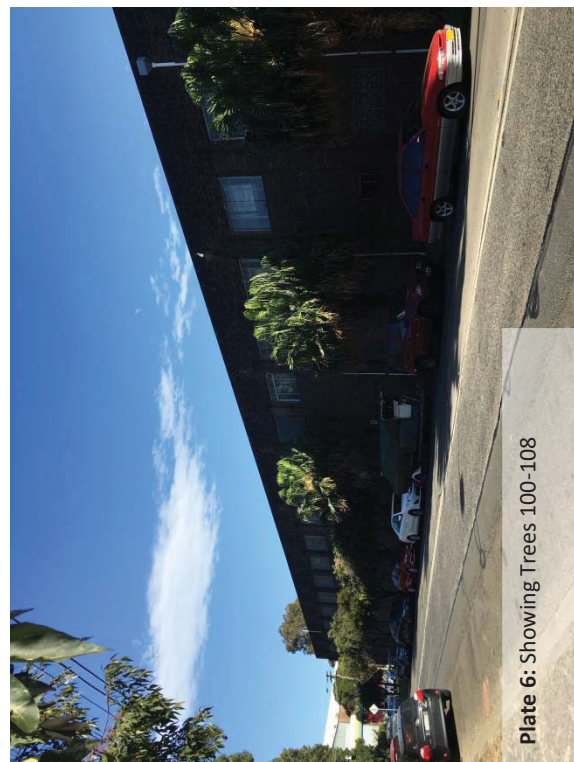


Plate 6: Showing Trees 100-108



Plate 7: Showing pruning Tree 75



Plate 8: Showing pruning Tree 76



Plate 9: Showing pruning Tree 77



Plate 10: Showing pruning Tree 78



Plate 11: Showing pruning Tree 80

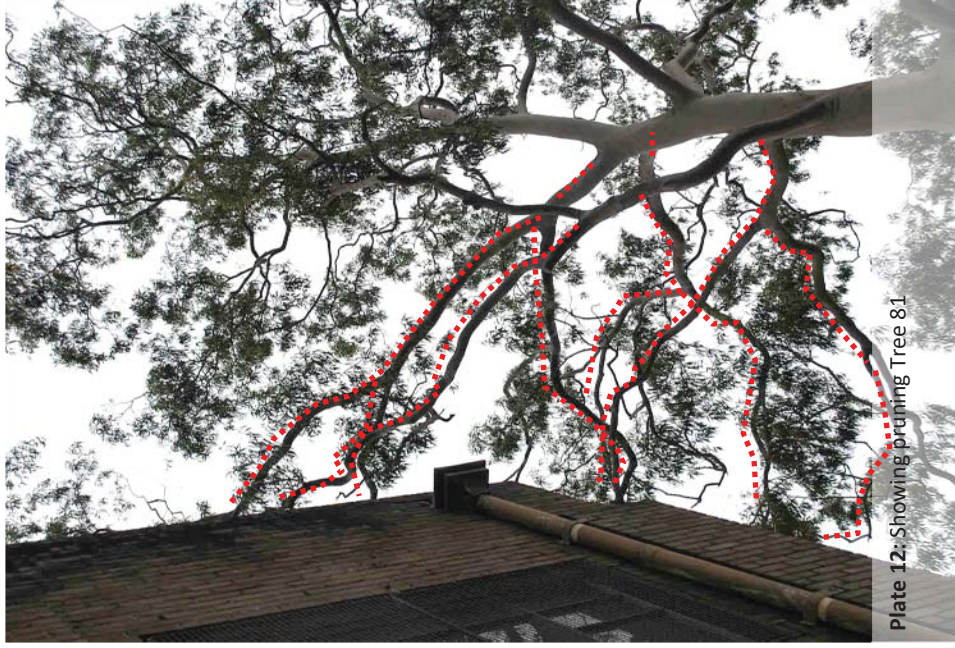


Plate 12: Showing pruning Tree 81



Plate 13: Showing pruning Tree 81



Plate 14: Showing pruning Tree 84

Appendix 5: Tree Protection Specification

1.0 Appointment of Project Arborist

A Project Arborist shall be engaged prior to the commencement of work on-site and monitor compliance with the protection measures. The Project Arborist shall inspect the tree protection measures and Compliance Certification shall be prepared by the Project Arborist for review by the Principal Certifying Authority prior to the release of the Compliance Certificate.

The Project Arborist shall have a minimum qualification equivalent (using the Australian Qualifications Framework) of NSW TAFE Certificate Level 5 or above in Arboriculture.

1.1 Compliance

Contractors and site workers shall receive a copy of these specifications a minimum of 3 working days prior to commencing work on-site. Contractors and site workers undertaking works within the Tree Protection Zone shall sign the site log confirming they have read and understand these specifications, prior to undertaking works on-site.

The Project Arborist shall undertake regular site inspections and certify that the works are being undertaken in accordance with this specification.

Compliance Documentation shall be prepared by the Project Arborist following each site inspection. The Compliance Documentation shall include documentary evidence of compliance with the tree protection measures and methods as outlined within this Specification. Upon the completion of the works, a final assessment of the trees shall be undertaken by the Project Arborist and future recommended management strategies implemented as required.

1.2 Tree Protection Zone

The trees to be retained shall be protected prior and during construction from activities that may result in an adverse effect on their health or structural condition. The area within the Tree Protection Zone (TPZ) shall exclude the following activities, unless otherwise stated:-

- Modification of existing soil levels, excavations and trenching
- Mechanical removal of vegetation
- Movement of natural rock
- Storage of materials, plant or equipment or erection of site sheds
- Affixing of signage or hoarding to the trees
- Preparation of building materials, refueling or disposal of waste materials and chemicals
- Lighting fires
- Movement of pedestrian or vehicular traffic
- Temporary or permanent location of services, or the works required for their installation
- Any other activities that may cause damage to the tree

NOTE: If access, encroachment or incursion into the TPZ is deemed essential, prior authorisation is required by the Site Arborist.

1.3 Site Management

Materials, waste storage, and temporary services shall not be located within the TPZ.

1.4 Scaffolding

Where possible, scaffolding shall not be located within the TPZ. Scaffolding shall not be in contact with the tree. As necessary, this shall be achieved by erecting scaffolding around branches. Branches shall be tied back and protected as deemed necessary by the Project Arborist. Refer to Typical Tree Protection Details (5) (**Appendix 6**).

1.5 Works within the Tree Protection Zones

In some cases works within the TPZ may be authorized by the determining authority. **These works shall be supervised by the Project Arborist.** When undertaking works within the TPZ, care should be taken to avoid damage to the tree's root system, trunks and lower branches.

If roots (>25mmØ) are encountered during the demolition, excavation and construction works, these roots must be retained in an undamaged condition and advice sought from the Project Arborist. Adjustment of final levels and design shall remain flexible to enable the retention of roots (>25mmØ) where deemed necessary by the Project Arborist.

1.6 Ground Protection

Where deemed necessary by the Project Arborist, machinery movements shall be restricted to areas of existing pavement or from areas of temporary ground protection such as ground mats or steel road plates. Refer to Typical Tree Protection Details (3) (**Appendix 6**).

1.7 Trunk Protection

Trunk protection shall be installed onto Trees 65-67, 75-78, 80, 81 and 84. Trunk protection shall be installed by wrapping padding (either carpet underlay or 10mm thick jute geotextile mat) around the trunk and first order branches to a minimum height of 2m. Timber battens (90 x 45mm) spaced at 150mm centres shall be strapped together and placed over the padding. Timber battens must not be fixed to the trees. Refer to Typical Tree Protection Details (3) (**Appendix 6**).

Branch protection shall be installed as deemed necessary by the Project Arborist.

1.8 Structure & Pavement Demolition

Demolition of existing structures/pavement within the TPZ shall be supervised by the Project Arborist. Machinery is to be excluded from the TPZ unless operating from the existing slabs, pavements or areas of ground protection (refer to Section 1.6). Machinery should not contact the tree's roots, trunk, branches and crown.

The existing pavement shall be carefully lifted by hand to minimise damage to the existing sub-base and to prevent damage to tree roots. Wherever possible, the existing sub-base material shall remain in-situ.

When removing slab sections within TPZ, machinery shall work backwards out of the TPZ to ensure machinery remains on undemolished sections of slab at all times. Wherever possible, footings or elements below grade shall be retained to minimise disturbance to the tree's roots.

Where deemed necessary by the Project Arborist, the structures shall be shattered prior to removal with a hand-operated pneumatic/electric breaker.

If roots (>25mmØ) are encountered during the demolition works, these roots must be retained in an undamaged condition and advice sought from the Project Arborist. Exposed roots shall be protected from direct sunlight, drying out and extremes of temperature by covering with a 10mm thick jute geotextile fabric. The geotextile fabric shall be kept in a damp condition at all times. Where the Project Arborist determines that the tree is using underground elements (i.e footings, pipes, rocks etc.) for support, these elements shall be left in-situ.

1.9 Pavement/Kerb Installation

Installation of the pavements and sub-base within the TPZ shall be supervised by the Project Arborist. The new surfaces and sub-base materials shall be placed at or above grade to minimise excavations and retain roots (unless prior root mapping results show above sensitive construction to be unnecessary).

If roots (>25mmØ) are encountered during the installation of the new sub-base and surfaces, these roots must be retained in an undamaged condition and advice sought from the Project Arborist. Adjustment of final levels and design shall remain flexible to enable the retention of structural roots (>25mmØ) where deemed necessary by the Project Arborist.

New sub-base material shall be a 20mm no-fines road base (Benedict Sand & Gravel - Product Code 20NF/RB or similar approved material). Recycled concrete aggregates shall not be used to avoid raising soil pH levels.

If required, bedding sand shall be a washed river sand (recycled crushed paving blends shall not be used). The bedding sand shall be consolidated with a pedestrian-operated plate compactor only. If possible, the pavement material shall be permeable.

Where required, new kerbs within the TPZ should be modified to bridge tree roots (>25mmØ) unless root pruning is approved and undertaken by the Project Arborist.

1.10 Underground Services

Underground service installation within the TPZ shall be supervised by the Project Arborist.

The installation of underground services shall be located outside of the TPZ. Where this is not possible, they shall be installed using either hydrovac or hand excavation methods with the services installed around/below roots (>25mmØ, or as determined by the Project Arborist).

Alternatively, boring methods may be used for underground service installation where the installation depth is greater than 800mm below existing grade. Excavations for starting and receiving pits for boring equipment shall be located outside of the TPZ or located to avoid roots (>25mmØ, or as determined by the Project Arborist).

1.11 Excavations, Root Protection & Root Pruning

Excavations and root pruning within the TPZ shall be supervised by the Project Arborist. Excavations within the TPZ shall be avoided wherever possible.

Excavations within the TPZ shall be undertaken by hand or using hydro vacuum excavation methods (or similar approved device) to protect tree roots. If there is any delay between excavation works and backfilling, exposed roots shall be protected from direct sunlight, drying out and extremes of temperature by covering with a 10mm thick jute mat. The mat shall be kept in a damp condition at all times.

No over-excavation, battering or benching shall be undertaken beyond the footprint of any structure unless approved by the Project Arborist. Hand excavation and root pruning shall be undertaken along the excavation line prior to the commencement of mechanical excavation to prevent tearing and shattering damage to the roots from excavation equipment.

Roots (>25mmØ) shall be pruned by the Project Arborist only. Roots (<25mmØ) may be pruned by the Principal Contractor. Root pruning shall be undertaken with clean, sharp secateurs or a pruning saw to ensure a smooth wound face, free from tears.

Damaged roots shall be pruned behind the damaged tissues with the final cut made to an undamaged part of the root.


1.12 Footings within the TPZ

Footing installation within TPZ areas shall be supervised by the Project Arborist. Other than for the isolated piers, all other parts of the structure shall be installed above grade.

Drilling/piling machinery shall be excluded from the TPZ unless operating from an area where ground protection has been installed (refer to Section 1.6) or from the existing slabs or pavements. Drilling/piling machinery shall be of a suitable size to not damage the trees' roots, trunk, branches and crown. No clearance pruning is permitted to allow for machinery access. Machinery shall work in conjunction with an observer to ensure that adequate clearance from trees is maintained at all times.

1.13 Plant Installation

Plant installation within the TPZ shall be undertaken using hand tools and roots (>25mmØ) shall be protected. No mechanical cultivation/ripping of soils shall be undertaken within the TPZ.

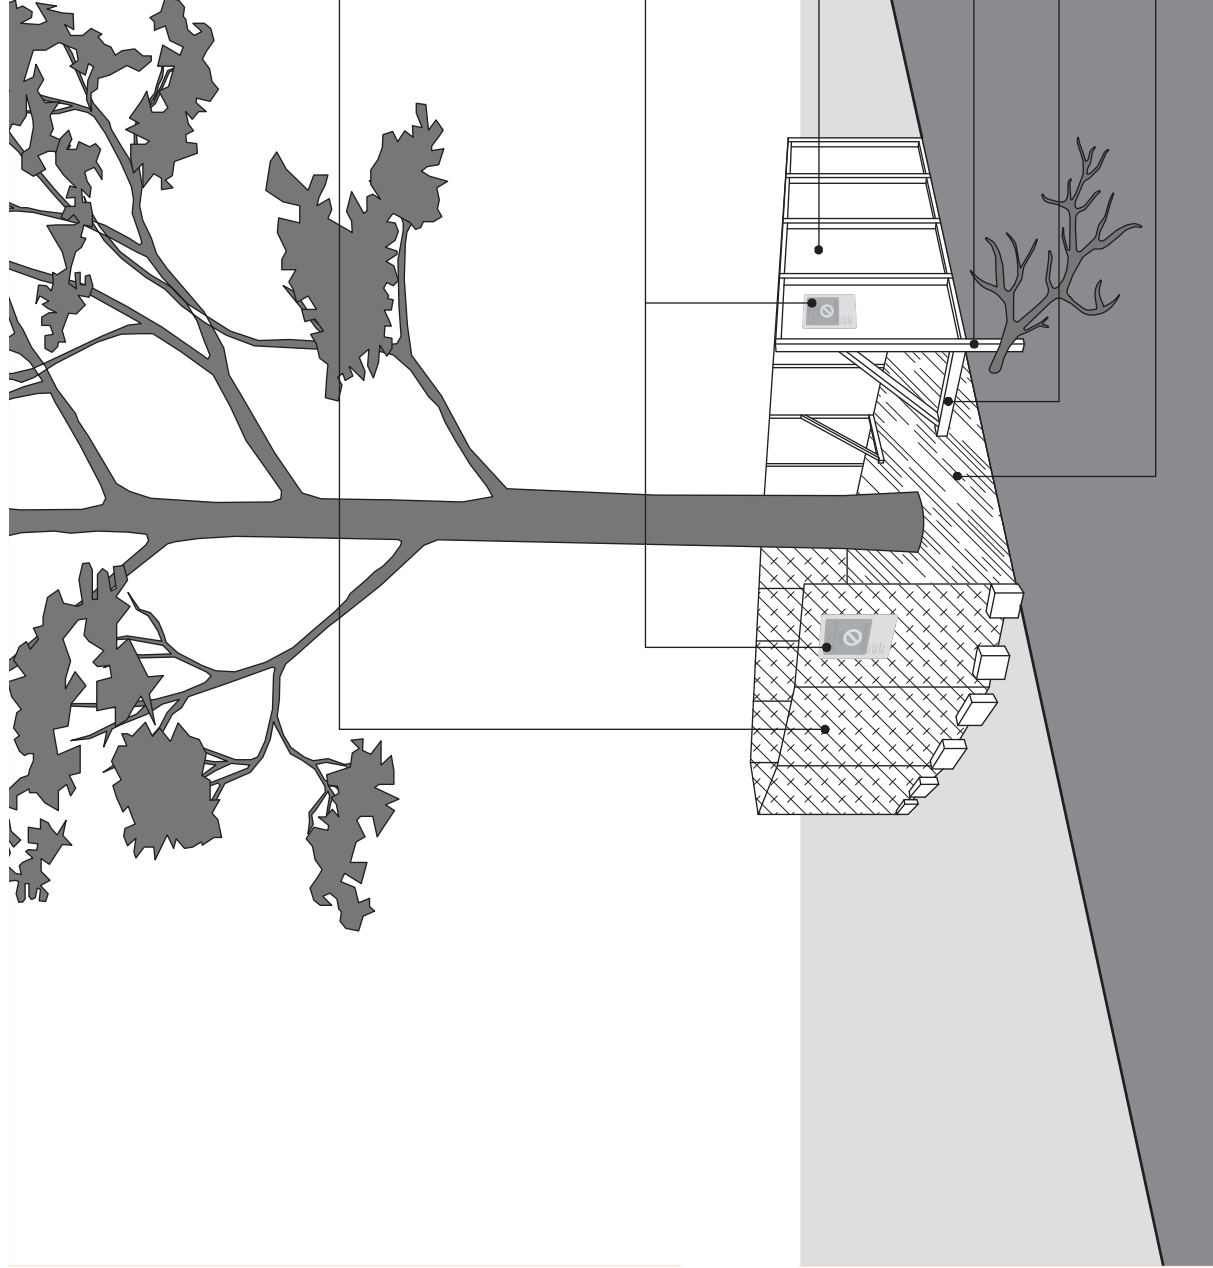

Note:

No excavation, construction activity, grade changes, surface treatment or storage of materials of any kind is permitted within the TPZ.

Option 1 - Fencing

1.8m high chain wire mesh panels with shade cloth attached (if required), held in place with concrete feet.

Tree Protection Zone (TPZ) sign


Option 2 - Fencing

Plywood or wooden panel paling fence. This type of fencing material also prevents building materials or soil entering the TPZ.

Installation of supports should avoid damaging roots.

Bracing is permissible within the TPZ.

Maximum 100mm and minimum 50mm depth mulch or aggregate layer installed across surface of TPZ.

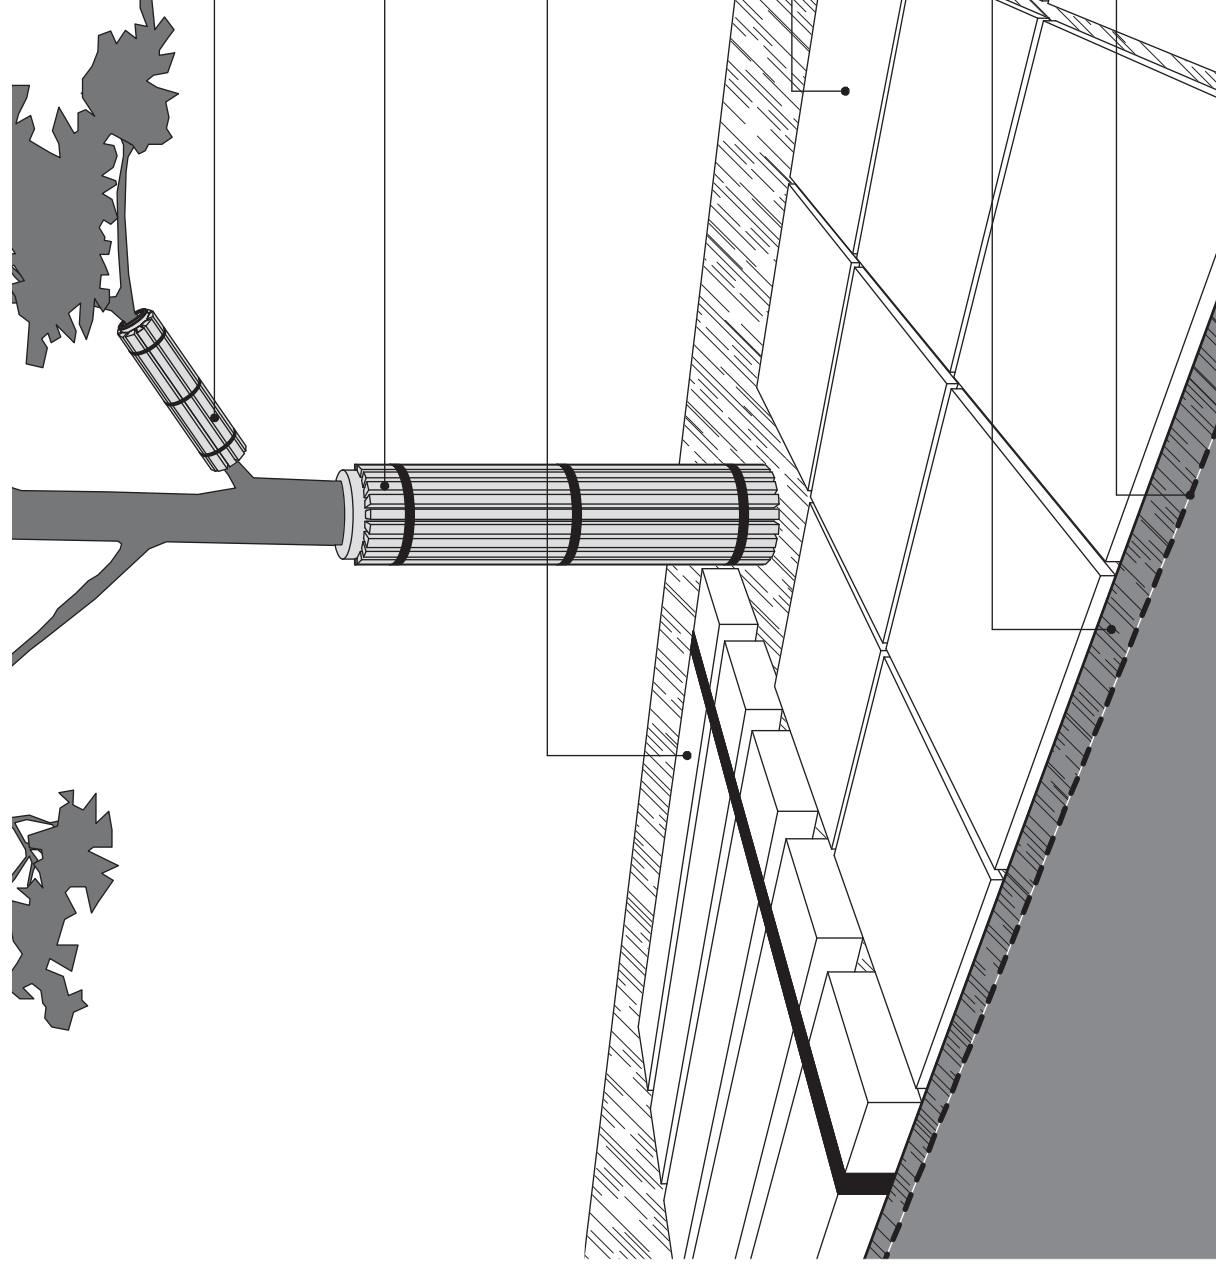

Branch Protection - use boards and padding to prevent damage to bark on branch. Boards are to be strapped, not screwed or nailed to the branch.


Trunk Protection - use boards and padding to prevent damage to bark (minimum 2m). Boards are to be strapped, not screwed or nailed to the trunk.

Ground Protection - use device strapped over mulch or aggregate layer. Ground protection device should be of a suitable thickness to prevent soil compaction and root damage.

Steel plates (or approved equivalent) with or without mulch or aggregate layer below.

Maximum 100mm and minimum 50mm depth mulch or aggregate layer.

Geotextile fabric underneath mulch or aggregate layer.

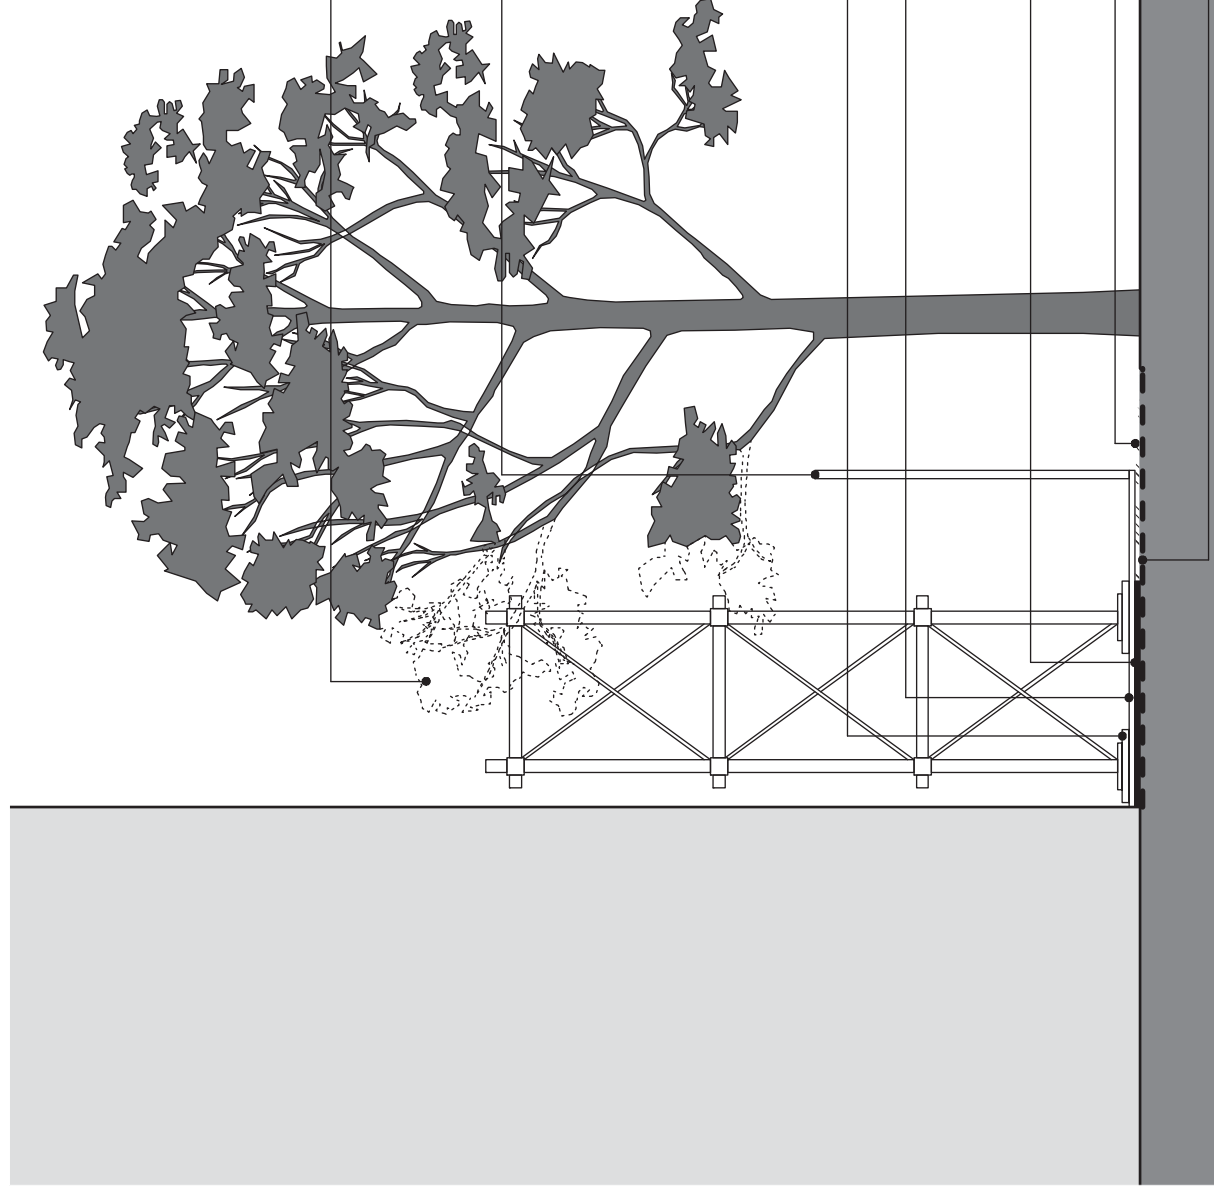

Branches may require pruning to erect scaffolding. Pruning may be subject to local regulations. Flexible branches should be tied back in preference to pruning.

Minimum 1.8m high hoarding. Temporary fencing may be incorporated into scaffolding as either containment screening or as hoarding.

Note:

If excavation is required for installation of support post for fencing, the Project Arborist should assess any pruning of roots greater than 20mm diameter.

Scaffold planks

Boards or plywood to be installed over mulch or aggregate layer for any areas requiring access within the TPZ.

Soleplate over geotextile. No excavation for soleplate within TPZ.

Maximum 100mm and minimum 50mm depth mulch or aggregate layer within TPZ.

Geotextile fabric