

# **ANGLICARE**

Sandon Point Village Bulli

s.75W Re-Submission

30.05.19

SUPPLEMENTARY REPORT

# **Architectural Drawings**

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# Precinct 1

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Individual building footprints are provided here to illustrate a potential outcome on the site.

Approval will be sought for the design of individual building forms in a future Project

A description of the components for which approval is sought is outlined in the accompanying report by Ethos Urban.

---- Indicative Building Footprint

1 s75W Re-Submission 2 Draft - s75W Re-Submission A Issued for Information
B Issued for Information C Issued for Information 3 s.75W Re-Submission


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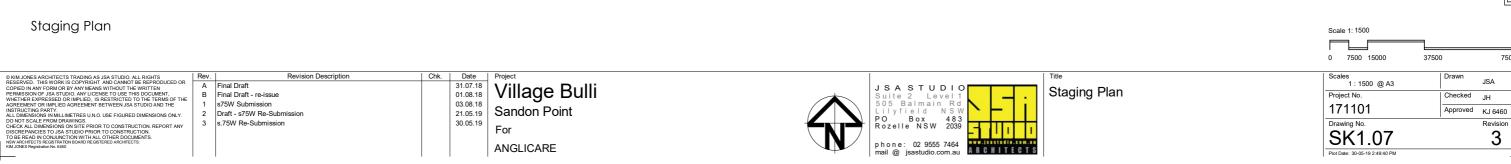


Indicative Subdivision Plan

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Project No.	Checked	JH
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PRECINCT 1

PRECINCT 3


WILKIES STREET

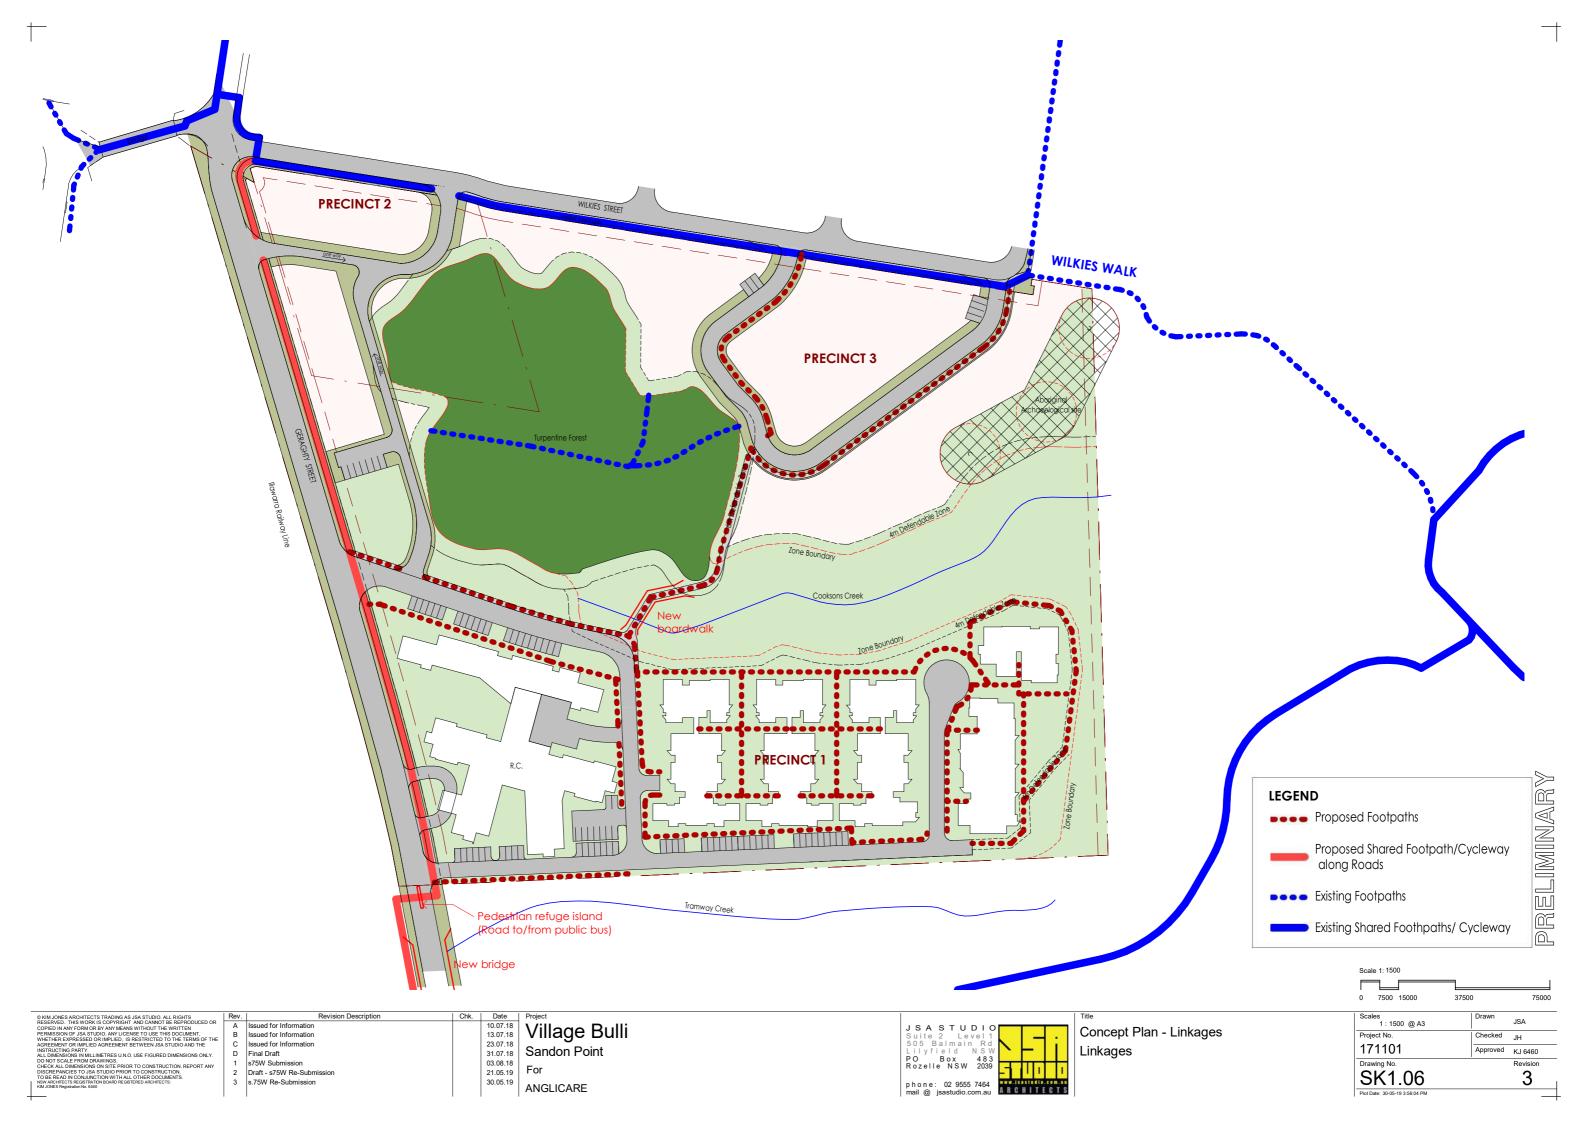Turpentine Forest

**1A** 

PRECINCT 2

2B

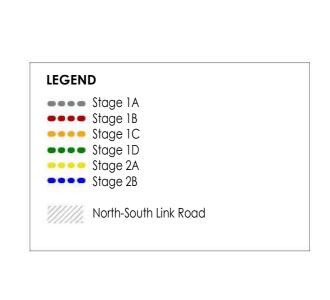

The objective with the design of the Anglicare development, Bulli is to enhance the sense of community. The site is situated adjacent to a remnant turpentine forest and wetland which requires minimal disturbance. Three distinct habitable precincts have been identified: Precincts 1, 2 and 3.

Precinct 1 is to be developed as a Retirement Village with approximately 140 ILUs and a Residential Care Facility. Precincts 2 and 3 are to be subdivided for up to 60 Townhouses.

The site generally has been designed in accordance with:

- Coastal Design Guidelines for NSW
- Crime Prevention Through Environmental Design

Precinct 1 specifically has been designed in accordance with:

- SEPP (Housing for Seniors or People with a Disability)
- SEPP 65 & Apartment Design Guide (ADG)

#### Coastal Design Guidelines for NSW

New Coastal Settlements: Villages and Hamlets best describes the type of development.

The proposed development takes into account the following design principles:

#### 2.1 Defining the Footprint & Boundary

The site is constrained by the natural environment in the form of the riparian corridor which bisects the site from east to west, the remnant turpentine forest and the aboriginal archaeological zone near the eastern boundary. Appropriate buffers are provided between the natural and built environments resulting in distinct boundary edges and clear compact settlement footprints. This has resulted in the creation of 3 distinct precincts - Precincts 1, 2 and 3.

The design takes into account the natural topography and concentrates small apartment buildings on the flat land in Precinct 1 and smaller semi-detached houses on the sloping land in Precincts 2 and 3.

# 2.2 Connecting Open Spaces

The natural features of the site - the riparian corridor and the existing remnant vegetation within the turpentine forest are linked and provide a continuous ecological corridor through the site linking to the riparian land and coastal edge to the east.

A pedestrian/cycle pathway will be continued along the infill section of the collector road on the western boundary. A pedestrian/cycle network will be established through the site linking to the western collector road and to Wilkies Walk and the beach access to the north east. The pedestrian/cycle paths will connect the three precincts of the site passing through the natural areas of the site with the aim of creating as minimal disturbance as possible.

Pedestrian pathways around the development define the edge between urban and natural and provide access for bushfire control and open up the land adjoining the natural areas to the public.

The Aboriginal archaeological zone will not be accessible. It will be preserved and maintained as a place of cultural heritage within the open-space network.

#### 2.3 Protecting the Natural Edges

All development on the site will be setback from the natural areas in order to protect the ecosystem and provide for bushfire protection.

The setbacks will also protect visual amenity of the riparian corridor.

Public access will be encouraged to the natural edges with public open spaces located adjoining the setback which are linked via a path network.

#### 2.4 Reinforcing the Street Pattern

A major collector road, Geraghty Street is proposed along the railway line on the western boundary linking the existing sections of the road to the north with the road to the south via a new bridge across Tramway Creek. This road links the site to the highway as well as the surrounding settlements.

On the site, the 3 precincts are separated by the natural features and will be accessed independently. In Precinct 3 on the sloping land to the north, the street pattern responds to the topography with roads accessed off Wilkies Street.

Precinct 2 will be accessed via a single lane internal road accessed from Geraghty Street. However, public open spaces will be provided between the developed areas so that the Turpentine Forest is accessible to the public.

Precinct 1 is on the flat land currently occupied by industrial buildings. A main street will run off Geraghty Street along the southern edge of the riparian corridor. Street-edge commercial and community facilities will located at around level to the south.

Views of the important natural features of the site are possible from the street network

Wayfinding and legibility will be promoted

High quality landscaping will be incorporated into the road reserves.

#### 2.5 Appropriate Buildings for a Coastal Context

New buildings will be located to protect views and vistas throughout the site and the surrounding areas from public places.

Small apartment buildings will be located on the lower flat section of the site in Precinct 1. These buildings will be screened by the existing riparian vegetation. Smaller 2 storey semi-detached residential buildings will be located on the sloping land to the north in Precincts 2 and 3 resulting in less visual impact and creating less overshadowing.

Two storey dwellings will align Wilkies Street creating a consistent height, bulk and scale with the street and the existing dwellings immediately to the north of the site.

Building materials will be carefully selected to blend with the existing coastal setting.



Compliance with Codes
Coastal Design Guidelines

Scales @ A3	Drawn	JSA
Project No.	Checked	JH
171101	Approved	KJ 6460
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 Village Bulli Sandon Point For ANGLICARE



View from within typical courtyard in Precinct 1

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3D View - Precinct 1

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171101	Approved	KJ 6460
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The design of the Site will satisfy the following 4 principles:

#### Surveillance

The courtyard style arrangement of buildings in Precinct 1 promotes passive surveillance with clear sightlines from windows in the ILUs over the common courtyard spaces as well as the periphery of the development. Houses in Precincts 2 and 3 will overlook the surrounding natural features - the riparian corridor and turpentine forest allowing for passive surveillance.

The landscaping will not provide concealment opportunities. Lighting will be provided to further enhance passive surveillance.

#### Access Control

In Precinct 1 the common courtyards will be attractive public spaces where people can meet and interact. Restricted access will be provided to the Lobbies and Carpark of the apartments.

# **Territorial Reinforcement**

The buildings in the Precinct 1 are arranged around common courtyards to create a sense of community. The surrounding landscapes will incorporate paths to encourage use and thereby passive surveillance. Links to the different precincts occur around the periphery of Precinct 1. Similarly the houses in Precincts 2 and 3 will be grouped to create small community enclaves.

#### **Space Management**

The Public spaces surrounding the buildings will be managed by an on-site manager in Precinct 1 to ensure that the spaces are maintained.



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Compliance with Codes Crime Prevention through Environmental Design

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Project No.	Checked	JH
171101	Approved	KJ 6460
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Following are indicative layouts for Precinct 1.

# The indicative plans:

- demonstrate that the development can be contained within the approved footprint with no encroachment into the E2 zone.
- include an indicative footprint for buildings in Precinct 1responsive to the site conditions and constraints.
- demonstrate along with the Views from the Sun shown on SKO.07 and SKO.08 that the future development can be oriented to maximise solar access to the dwellings.
- show that perimeter roads are maintained and appropriate buffers are provided to the riparian corridors
- show adjustments to the road network to accommodate the revised built form
- indicate that sufficient passive and active open space is provided for the expected additional population and demographic.
- show that permeability is maintained through the site with links to the beach.
- show that there will be minimal potential for vehicle, bicycle and pedestrian conflicts.
- demonstrate that the proposed building envelopes would facilitate appropriate design within the site's setting
- together with SK2.11 demonstrate that the proposed building envelopes would achieve compliance with the approved maximum height, site coverage and FSR controls




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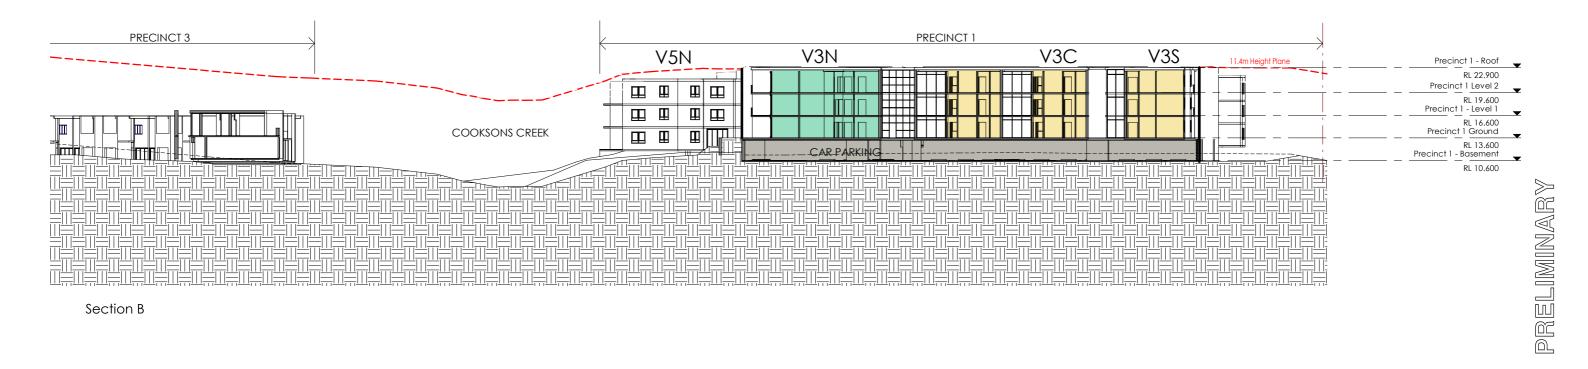
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ANGLICARE

phone: 02 9555 7464 mail @ jsastudio.com.au



Section A - Section through Precinct 1

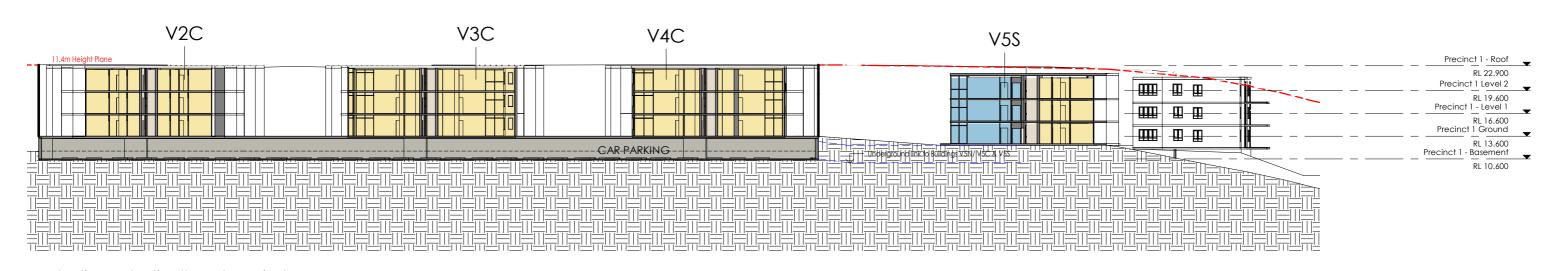

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View looking north over typical courtyard in Precinct 1

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3D View - Precinct 1

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Drawing No.		Revision
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21.05.19

13.05.19 30.05.19 ANGLICARE

JSASTUDIO phone: 02 9555 7464 mail @ jsastudio.com.au

Basement Floor Plan Precinct 1 - Indicative Parking Layout

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SK3.40



# **LEGEND**



	PARKING - R.C.		
	SPACES	REQUIRED	PROVIDED
R.C. (60 std beds)	Residents/ Visitors	1/10 beds 6	9
(20 dementia beds)		1/15 beds 2	2
	Staff (40 max.)	1/2 staff 20	20
TOTAL		28	31

# PARKING - Cafe/ Community Facilities

12 spaces are provided for the Cafe/Community Facilities. The community facilities are to be mainly used by the residents of the site who will not require parking. The 12 spaces will be available for visitors from the broader community.

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2500 5000	12500	25000

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Precinct 1 - Indicative Parking Layout

Scales As indicated @ A3	Drawn	JSA
Project No.	Checked	JH
171101	Approved	KJ 6460
Drawing No.		Revision
SK3.42		2

### SEPP (Housing for Seniors or People with a Disability)

Density & Scale: FSR is 0.36:1

Landscaped area: 140 x 35sqm = 4900sqm required. Over 7,500 sqm provided

Deep Soil Zones: Approximately 32% of the site is deep soil.

Solar Access: a minimum 70% of dwelling received 3 hours of direct sunlight between 9am and 3pm in mid-

Parking: 0.5 car spaces have been provided per bedroom


Siting Standards: 100% of dwellings will be wheelchair accessible by a continuous path of travel from a public road in accordance with AS1428.1. Access will be provided to common areas in accordance with AS1428.1.

Security: Pathway lighting will be designed to comply

Letterboxes: will be designed to comply

Private Car Accommodation: Carparking spaces have been provided in accordance with the AS2890 requirements for parking for persons with a disability. 5% are capable of being increased to 3.8m. The carpark will have a power-operated door.

Refer following layout for a typical unit showing compliance with SEPP (Housing for Seniors or People with a

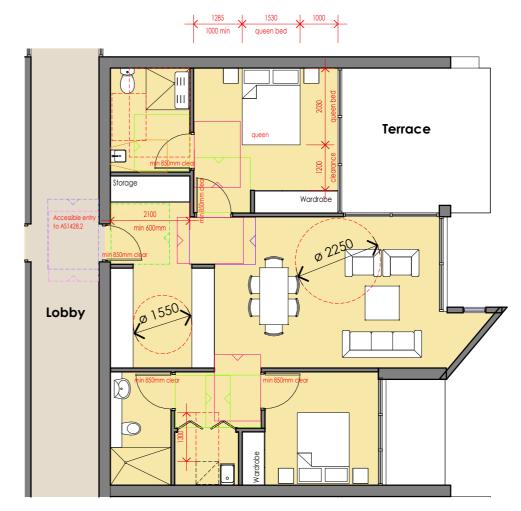


Typical Precinct 1 Apartment Plan - SEPP (HSPD) Compliant Indicative Layout only

SEPP (HSPD) requirements shown in red Circulation spaces to entry door to AS1428.2 Circulation spaces to internal doors to AS1428.1

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Village Bulli **ANGLICARE** 

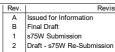

Compliance with Codes SEPP (Housing for Seniors or People with a Disability)

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171101	Approved	KJ 6460	
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SK0.04		3	
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# SEPP 65 & Apartment Design Guide

The design of the apartment buildings in the Precinct 1 has been prepared by the firm JSA Studio under the direction of Kim Charles Jones being a Registered Architect in the State of NSW. The design acknowledges the Design Quality Principles set out in SEPP 65 and in accordance with the design criteria outlined in the Apartment Design Guide (ADG).

Refer to the ADG checklist and commentary sheets following for compliance.

	RTMENT DESIGN Criteria	GUIDE		COMMENT	COMPLIES
Objec An ade	Communal & Pul tive 3D-1 quate area of communal ce residential amenity and spring	open space a	s provided to		
Design	n criteria				
100	Communal open space has 5% of the site (see figure		area equal to	Precinct 1 site area: 27,699 m <sup>2</sup> Precinct 1 Communal Open Space: 7,902.5m <sup>2</sup> (28%)	✓
91	Developments achieve a unlight to the principal us open space for a minimur and 3 pm on 21 June (min	sable part of the n of 2 hours b	ne communal		✓
3E D	eep Soil Zones				
Deep s and sup residen air qual	ctive 3E-1 coll zones provide areas of ppoor healthy plant and to that amenity and promote lity n criteria				
1. D	Deep soil zones are to me equirements:	eet the following	ng minimum	Precinct 1 site area : 27,699 m² Precinct 1 deep soil area : 8,922m² (32%)	/
	Site area		ep soil zone of site area) 7%		
Object Adequa betwee externa	isual Privacy  tive 3F-1  are building separation di in neighbouring sites, to a al and internal visual priva				
1.	Separation between wir provided to ensure visu Minimum required sepa buildings to the side and follows:	al privacy is a ration distano	chieved, es from	All buildings are three storey and under 12m The minimum separation distance between buildings is 10.8m but blank walls and screens have been used to maximise privacy.	✓
	Building height	Habitable rooms and balconies	Non- habitable rooms		
	up to 12m (4 storeys)	6m	3m		
	up to 25m (5-8 storeys)	9m	4.5m		
Note:	over 25m (9+ storeys)  Separation distances by site should combine red depending on the type of the storeys)	quired building	separations		
	Gallery access circulation habitable space when no distances between neighbors.	neasuring priv	racy separation		

	ARTMENT DESIGN GUIDE gn Criteria	COMMENT	COMPLIES
3J	Bicycle & Car Parking		
Obj	ective 3J-1		
Des	sign criteria		
1.	For development in the following locations:  on sites that are within 800 metres of a railway station or light rail stop in the Sydney Metropolitan Area: or		N/A
	on land zoned, and sites within 400 metres of land zoned, B3 Commercial Core, B4 Mixed Use or equivalent in a nominated regional centre	Site is NOT within 400m of land zoned B3 Commercial Core, B4 Mixed Use or equivalent in a nominated regional centre	N/A
	the minimum car perking requirement for residents and visitors is set out in the Guide to Traffic Generating Developments, or the car parking requirement prescribed by the relevant council, whichever is less		
	The car parking needs for a development must be provided off street		
4A	Solar & Daylight Access		
Obj	ective 4A-1		
	plimise the number of apartments receiving sunlight to table rooms, primary windows and private open space.		
Des	sign criteria	Refer Views from the Sun following	
1.	Living rooms and private open spaces of at least 70% of apartments in a building receive a minimum of 2 hours direct sunlight between 9 am and 3 pm at mid winter in the Sydney Metropolitan Area and in the Newcastle and Wollongong local government areas		N/A
2.	In all other areas, living rooms and private open spaces of at least 70% of apartments in a building receive a minimum of 3 hours direct sunlight between 9 am and 3 pm at mid winter	77% of units receive the minimum 3 hours of direct sunlight between 9am and 3pm at mid winter	✓
3.	A maximum of 15% of apartments in a building receive no direct sunlight between 9 am and 3 pm at mid winter	12 out of 140 units (8.5%) receive no direct sunlight between 9am and 3pm at mid winter	<b>√</b>
4B	Natural Ventilation		
ОЫ	ective 4B-3		
	number of apartments with natural cross ventilation is		
	imised to create a comfortable indoor environment for dents		
Des	sign criteria		
1.	At least 60% of apartments are naturally cross ventilated in the first nine storeys of the building.	70% of apartments are dual aspect, corner or cross-through apartments.	<b>√</b>
	Apartments at ten storeys or greater are deemed to be cross ventilated only if any enclosure of the balconies at these levels allows adequate natural ventilation and cannot be fully enclosed		
		Cross-through apartments are maximum 8m	

	PARTMENT DE ign Criteria	SIGN GUIDE	COMMENT	
4C	Ceiling Hei	ghts		
Ohi	ective 4C-1			
Ceili		sufficient natural ventilation and		
	ign criteria			
1.		inished floor level to finished ceiling eiling heights are:		
	Minimum ceiling for apartment and	j height I mixed use buildings	3.0m floor to floor has been provided to allow for required ceiling heights	✓
	Habitable rooms	2.7m	The state of the s	
	Non-habitable	2.4m		
	For 2 storey apartments	2.7m for main living area floor     2.4m for second floor, where its area does not exceed 50% of the apartment area		
	Attic spaces	1.8m at edge of room with a 30 degree minimum ceiling slope.		
	If located in mixed used areas	3.3m for ground and first floor to promote future flexibility of use		
	These minimums desired	do not preclude higher ceilings if		
Obj The orga Des	ective 4D-1 layout of rooms wi nised and provides sign criteria	Size & Layout thin an apartment is functional, well is a high standard of amenity		
<i>Obj</i> The orga	lective 4D-1 layout of rooms withinsed and provides bign criteria  Apartments are minimum internal	thin an apartment is functional, well s a high standard of amenity equired to have the following areas:		
Obj The orga Des	lective 4D-1 layout of rooms virinised and provides sign criteria Apartments are n minimum interna Apartment typ	thin an apartment is functional, well is a high standard of amenity equired to have the following lareas:		<b>√</b>
Obj The orga Des	lective 4D-1 layout of rooms virinised and provides sign criteria Apartments are n minimum interna Apartment typ Studio	thin an apartment is functional, well is a high standard of amenity equired to have the following lareas:  Minimum internal area  35m²		√
Obj The orga Des	lective 4D-1 Isyout of rooms virinised and provides sign criteria Apartments are n minimum interna Apartment typ Studio 1 bedroom	thin an apartment is functional, well is a high standard of amenity equired to have the following I areas:  Minimum internal area  35m²  50m²		✓
Obj The orga Des	lective 4D-1 layout of rooms virinised and provides sign criteria Apartments are n minimum interna Apartment typ Studio	thin an apartment is functional, well is a high standard of amenity equired to have the following lareas:  Minimum internal area  35m²		✓
Obj The orga Des	lective 4D-1 Isyout of rooms with resed and provides sign criteria Apartments are minimum internal Apartment types studio 1 bedroom 2 bedroom 3 bedroom The minimum internal A fourth bedroom	thin an apartment is functional, well is a high standard of amenity equired to have the following lareas:    Minimum internal area   35m²   50m²   70m²   90m²		✓
Obj The organization of the organization of th	lective 4D-1 Isyout of rooms with insed and provides and provides and provides and provides and provides are minimum internal.  Apartment type Studio.  1 bedroom. 2 bedroom. 3 bedroom. The minimum internal and fourth bedroom increase the minimum set.	thin an apartment is functional, well is a high standard of amenity equired to have the following lareas:    Minimum internal area   35m²   50m²   70m²   90m²		✓
Obj The orga Des	lective 4D-1 Layout of rooms virinised and provides bign criteria Apartments are minimum interna Apartment typ Studio 1 bedroom 2 bedroom 3 bedroom The minimum interna A fourth bedroom increase the minimum interna Every habitable redeemal wall with less than 10% of	thin an apartment is functional, well is a high standard of amenity equired to have the following lareas:    Minimum internal area   35m²   50m²   70m²   90m²		✓ ✓
Obj The orga Des 1.	lective 4D-1 Isyout of rooms with insed and provides align criteria Apartment types and insert and	thin an apartment is functional, well is a high standard of amenity equired to have the following lareas:    Minimum internal area   35m²   50m²   70m²   90m²		✓ ✓
Obj The orga Des 1.	lective 4D-1 Isyout of rooms with insed and provides align criteria Apartment types and insert and	thin an apartment is functional, well is a high standard of amenity equired to have the following laroas:    Minimum internal area   35m²   50m²   70m²   90m²		✓ ✓
Obj The orga Des 1.	lective 4D-1 Layout of rooms with read and provides bign criteria  Apartments are minimum interna  Apartment typ Studio 1 bedroom 2 bedroom 3 bedroom  The minimum interna A fourth bedroom increase the minimum interna Every habitable resternal wall with less than 10% of and air may not be rective 4D-2 ronmental performs sign criteria	thin an apartment is functional, well is a high standard of amenity equired to have the following lareas:    Minimum internal area   35m²   50m²   70m²   90m²		✓ ✓

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 Date

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 23.07.18

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 31.07.18

 W Submission
 03.08.18

 ft - s75W Re-Submission
 21.05.19

 5W Re-Submission
 30.05.19

Village Bulli

Sandon Point

ANGLICARE

For





Compliance with Codes SEPP 65 & ADG

Scales 1:100 @ A3	Drawn	JSA
Project No.	Checked	JH
171101	Approved	KJ 6460
Drawing No.		Revision
SK0.05		3
Plot Date: 30-05-19 3:41:42 PM		

APARTMENT DESIGN GUIDE Design Criteria				COMMENT	COMPLIES
4D	(cont'd)				
Obj	iective 4D-3				
	rtment layouts are designed sehold activities and needs	to accommo	date a variety of		
	sign criteria				
1.	Master bedrooms have a n other bedrooms 9m² (exclu				✓
Bedrooms have a minimum dimension of 3m (excluding wardrobe space)					<b>√</b>
3.	Living rooms or combined minimum width of:  3.6m for studio and 1 be 4m for 2 and 3 bedroom	edroom apar	tments		✓
4.	The width of cross-over or are at least 4m internally to apartment layouts				<b>√</b>
Des	rtments provide appropriately balconies to enhance reside sign criteria	ntial amenit	,		
1.	All apartments are requi balconies as follows:	red to have	primary		
	Dwolling type	Minimum area	Minimum depth		
	100				
	Studio apartments	4m²	3		
		8m²	- 2m		✓
	Studio apartments  1 bedroom apartments  2 bedroom apartments	8m² 10m²	2m		✓
	Studio apartments  1 bedroom apartments	8m² 10m² 12m² epth to be o	2m 2.4m ounted as		✓
2.	Studio apertments  1 bedroom apertments  2 bedroom apertments  3+ bedroom apertments  The minimum balcony d	8m <sup>2</sup> 10m <sup>2</sup> 12m <sup>2</sup> epth to be cony area is 10 d level or or te open spanust have a	2.4m 2.4m ounted as m a podium or ce is provided minimum area		√ √
	Studio apartments  1 bedroom apartments  2 bedroom apartments  3+ bedroom apartments  The minimum balcony discontributing to the balco  For apartments at groun similar structure, a privainstead of a balcony. It is	8m² 10m² 12m² epth to be cony area is 10 d level or or te open spanust have a depth of 3m	2m 2.4m counted as m a podium or ce is provided minimum area		√ √
4F Obj	Studio apartments  1 bedroom apartments  2 bedroom apartments  3+ bedroom apartments  The minimum balcony discontributing to the balco  For apartments at groun similar structure, a priva instead of a balcony. It not 15m² and a minimum	9m² 10m² 12m² epth to be or nny area is 1 ind level or or te open spannist have a depth of 3m some Spannist have some Spanni	2m 2.4m counted as m a podium or ce is provided minimum area		√ √
4F Obj Com prop	Studio apartments  1 bedroom apartments  2 bedroom apartments  3+ bedroom apartments  The minimum balcony dicontributing to the balco  For apartments at groun similar structure, a priva instead of a balcony, it is of 15m² and a minimum  Common Circulation  Cottive 4F-1  mon circulation spaces achi	9m² 10m² 12m² epth to be or nny area is 1 ind level or or te open spannist have a depth of 3m some Spannist have some Spanni	2m 2.4m counted as m a podium or ce is provided minimum area		√ ✓
4F Obj Com prop	Studio apartments  1 bedroom apartments  2 bedroom apartments  3+ bedroom apartments  The minimum balcony discontributing to the balcon similar structure, a privainstead of a balcony. It nof 15m² and a minimum  Common Circulation of a balcony of the balcon of the balcony of t	8m² 10m² 12m² epth to be or any area is 1: id level or or te open spannust have a depth of 3m from & Sp eve good ar partments	2m 2.4m counted as m a podium or ce is provided minimum area  acces	Apartment blocks have more than 8 apartments off a circulation core but the blocks are made up of essentially 2 linked cores.	√ √

	ARTMENT DESIGN ( In Criteria	GUIDE	COMMENT	COMPLI
4G	Storage			
	ective 4G-1 uate, well designed storage ment	is provided in each		
Desi	gn criteria			
1.	In addition to storage in bedrooms, the following	kitchens, bathrooms and storage is provided:	50% of the storage will be located in the carpark.	
	Dwelling type	Storage size volume		
	Studio apartments	4m³		,
	1 bedroom apartments	6m <sup>s</sup>		✓
	2 bedroom apartments	8m²		
	3+ bedroom apartments	10m <sup>2</sup>		


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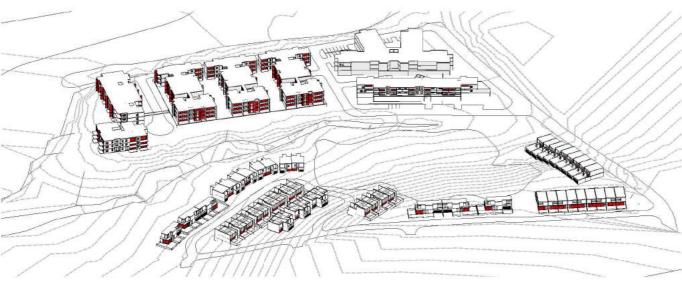


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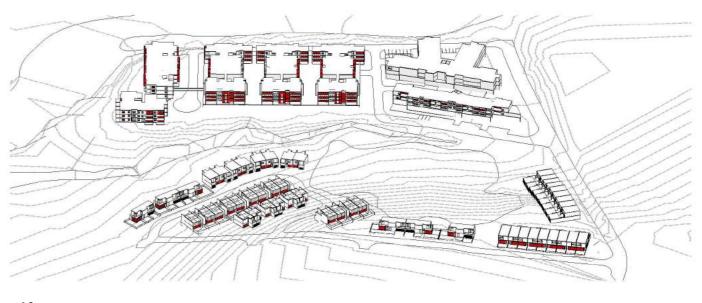
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171101	Approved	KJ 6460
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9am



11am

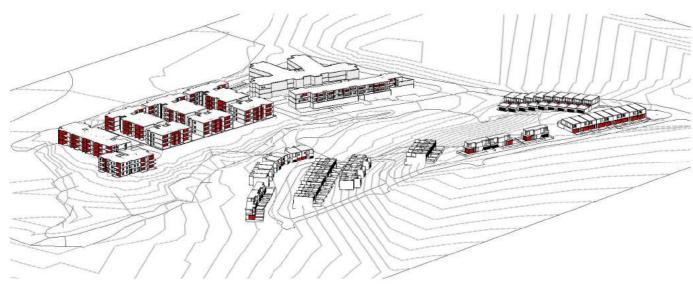

12 noon

Living room windows

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Final Draft s75W Submission Draft - s75W Re-Submis s.75W Re-Submission

27.03.18 04.05.18 20.07.18 23.07.18 31.07.18 03.08.18 21.05.19 30.05.19

Project

Village I

Sandon Poir

For

ANGLICARE Village Bulli Sandon Point Issued for Information Re-issued for Information Drawing Renumbered Issued for Information

JSASTUDIO Suite 2 Level 1 505 Balmain Rd Lilyfield NSW PO Box 483					
Rozelle NSW 2039	-	I	1		1
phone: 02 9555 7464 mail @ jsastudio.com.au	A R C	H I	T E	C	T S

Compliance with Codes Views from the Sun 9am -12pm

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Drawing No.	·	Revision
SK0.07		3
Plot Date: 30-05-19 5:07:50 PM		





2pm



# **PRECINCT 2 SOLAR ACCESS**

Refer SK0.09 - SK0.10

# PRECINCT 3 SOLAR ACCESS

Refer SK0.11 - SK0.12

Living room windows

# PRECINCT 1 APARTMENT SOLAR ACCESS

APARTMENT BLOCKS	Achieves 3hr sunlight	Total Units
/1N	8	8
/2N	9	9
/2C	9	12
/2\$	6	9
/3N	9	9
/3C	9	12
/3\$	6	9
/4N	9	9
/4C	9	12
/4\$	6	9
/5N	9	15
/5C	15	21
/5\$	4	6

TOTAL: 108 UNITS 140 UNITS 77% achieves min 3hr Solar Access

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3pm

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Project No.	Checked	JH
171101	Approved	KJ 6460
Drawing No.		Revision
SK0.08		3
Plot Date: 30-05-19 4:47:36 PM		

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Date 23.07.18 31.07.18 03.08.18 21.05.19 30.05.19 Sandon Point For ANGLICARE



3D View - Precinct 1

Scales @ A3	Drawn	JSA
Project No.	Checked	JH
171101	Approved	KJ 6460
Drawing No.		Revision
SK7.38		3
Plot Date: 30-05-19 4:37:41 PM		

Following are indicative layouts for Precincts 2 & 3.

# The indicative plans:

- demonstrate that the development can be contained within the approved footprint with no encroachment into the Turpentine forest.
- include an indicative subdivision pattern responsive to the site conditions and constraints.
- demonstrate along with the Views from the Sun shown on SK0.09 SK0.12 that the future development lots can be oriented to maximise solar access to the dwellings.
- show that perimeter roads are maintained and appropriate buffers are provided to the riparian corridors
- show adjustments to the road network to accommodate the revised built form
- indicate that sufficient passive and active open space is provided for the expected additional population and demographic.
- show that permeability is maintained through the site with links to the beach.
- show that there will be minimal potential for vehicle, bicycle and pedestrian conflicts.
- demonstrate that the proposed building envelopes would facilitate appropriate design within the site's setting
- together with SK2.11 demonstrate that the proposed building envelopes would achieve compliance with the approved maximum height, site coverage and FSR controls



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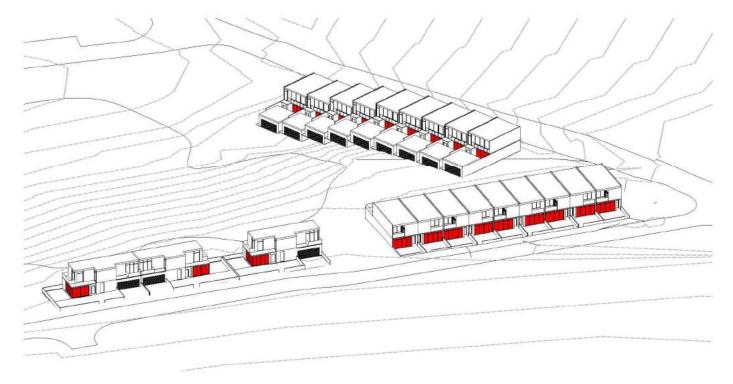
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Suite 2 Level 1
505 Balmain Rd
Lilyfield NSW
PO Box 483
Rozelle NSW 2039

phone: 02 9555 7464
mail @ jsastudio.com.au


Precincts 2 & 3 Plan Indicative Lot Plan

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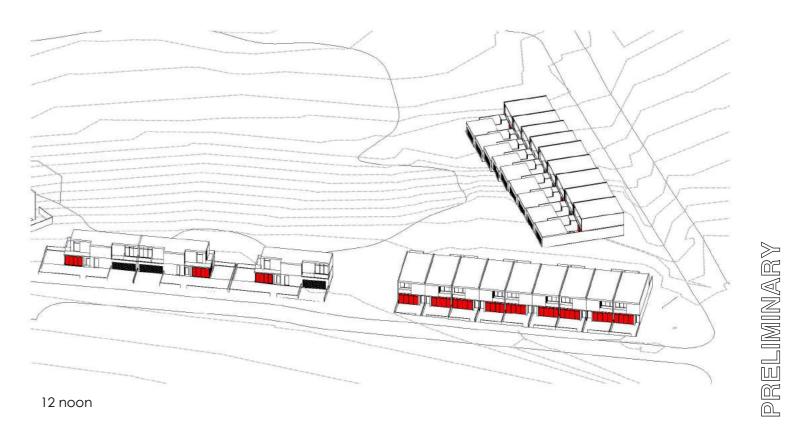
PRELIMINARY



9am

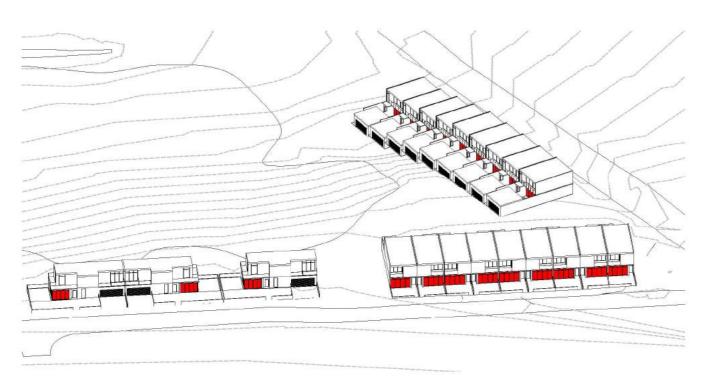

10am



11am

Living room windows


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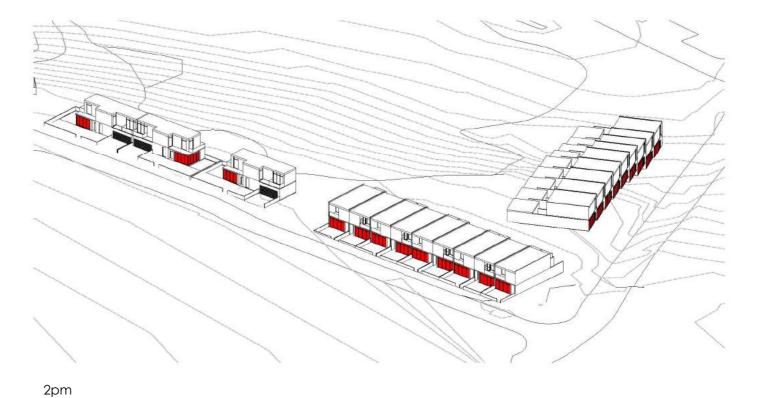
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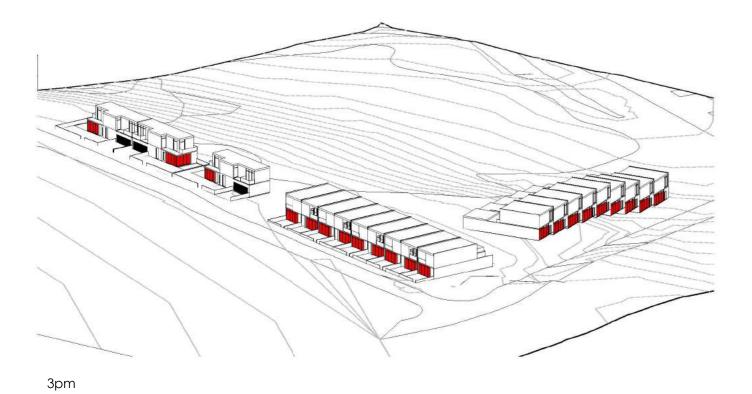
Compliance with Codes
Views from the Sun 9am -12pm
Precinct 2


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171101	Approved	KJ 6460
Drawing No.		Revision
SK0.09		2
Plot Date: 30-05-19 4:43:54 PM		





1pm

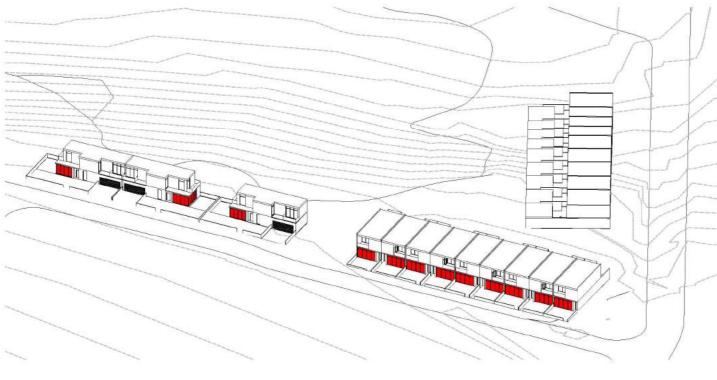

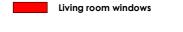

**PRECINCT 2 SOLAR ACCESS** 

PRECINCT 2
100% of the 21 Townhouses receive 3+ hours of direct sunlight mid-winter between 9am and 3pm

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Village Bulli Sandon Point 
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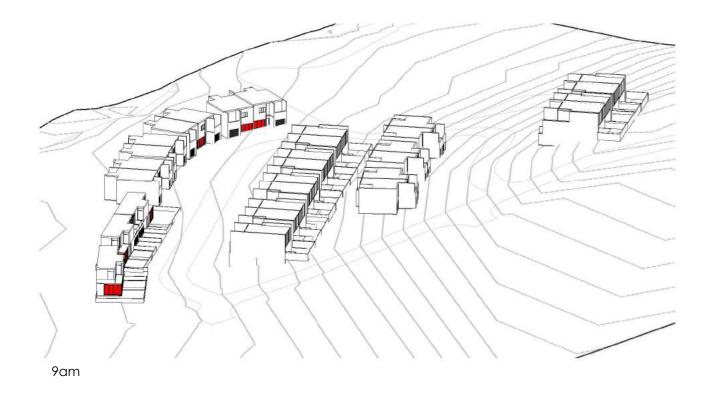
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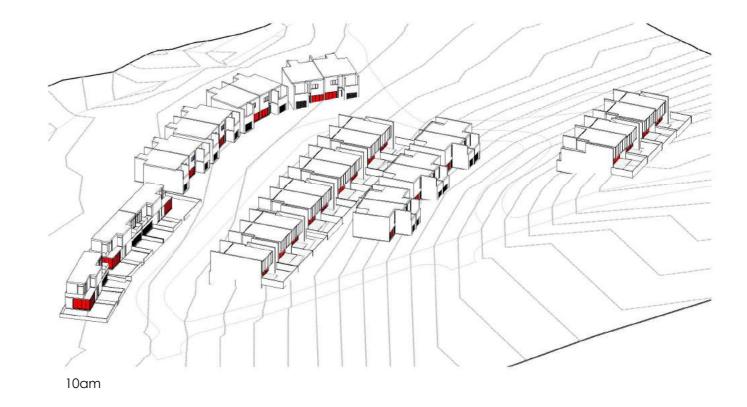
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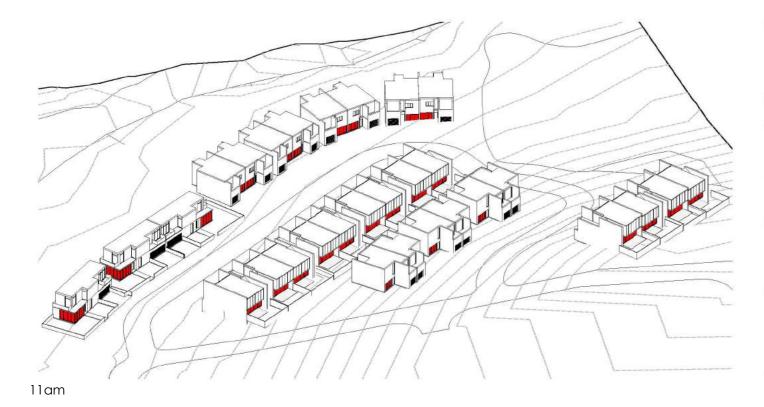


Compliance with Codes Views from the Sun 1pm - 3 pm Precinct 2

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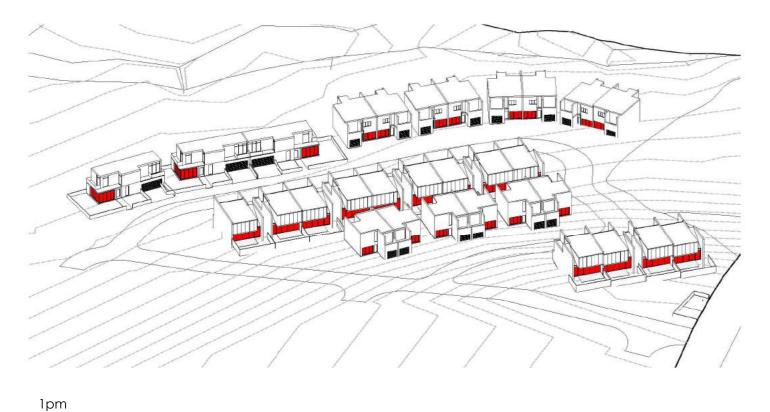
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Suite 2 Level 1 505 Balmain Rd	\
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Compliance with Codes
Views from the Sun 9am -12pm
Precinct 3


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Plot Date: 30-05-19 4:41:06 PM		

Living room windows

PRELIMINARY





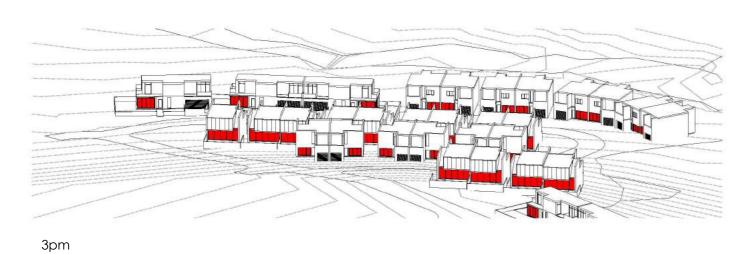

Living room windows PRECINCT 3 SOLAR ACCESS

PRECINCT 3
100% of the 30 Townhouses receive 3+ hours of direct sunlight mid-winter between 9am and 3pm

Note one townhouse receives the 3 hours of direct sunlight from 9: 30am - 12:30pm

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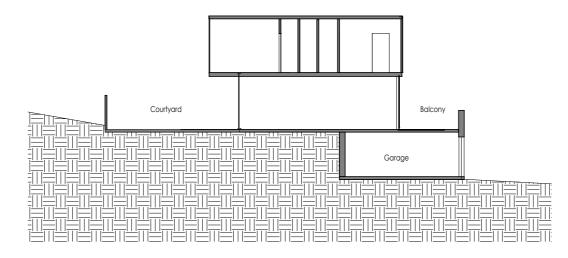
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Compliance with Codes Views from the Sun 1pm - 3 pm Precinct 3

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Plot Date: 30-05-19 4:39:50 PM		

Lot Size varies 220m<sup>2</sup> - 295m<sup>2</sup> Internal Area 120m<sup>2</sup> External Courtyard area varies min. 137m<sup>2</sup>



Section F

### Solar Access

13 of the 13 townhouses of this type receive a min. of 4 hours of direct sunlight at the winter solstice

# Privacy

The arrangement of the townhouses together with the positioning of windows, use of screens and blade walls will minimise overlooking of neighbouring private open space and windows.

## Open Space


Private open space varies with a minimum of 62 sqm. A courtyard area is located at the rear of the dwelling (approx.




Key Plan Indicative Locations


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Level 2 Plan

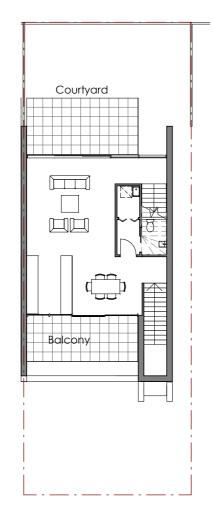

Ground Floor Plan

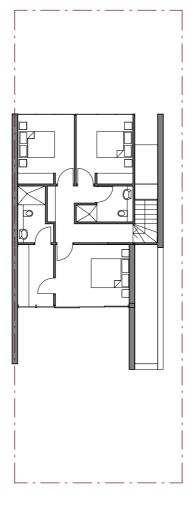Indicative Layout only

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02.02.18 23.03.18 Village Bulli 13.07.18 23.07.18 Sandon Point For 03.08.18

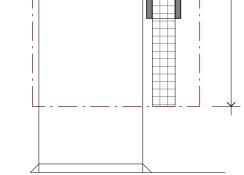21.05.19 30.05.19 ANGLICARE

Level 1 Plan







Townhouses - Typical North-South Lots

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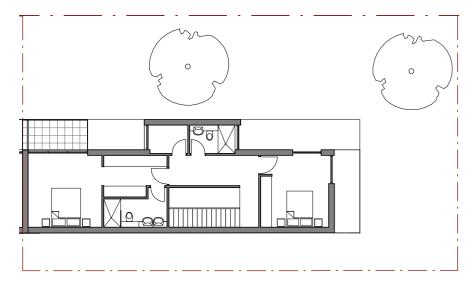
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s.75W Re-Submission

phone: 02 9555 7464 mail @ jsastudio.com.au

2 Bed /2.5Bath / 2 Onsite Parking


Lot Size varies 330m<sup>2</sup> - 447m<sup>2</sup> Internal Area 118m<sup>2</sup> External Courtyard area varies min.167m<sup>2</sup>



2 Level 1 Plan



23.03.18 27.03.18 13.07.18 23.07.18 31.07.18 03.08.18 Issued for Information Issued for Information Village Bulli ssued for Information Sandon Point Issued for Information For s75W Submission 21.05.19 30.05.19 ANGLICARE

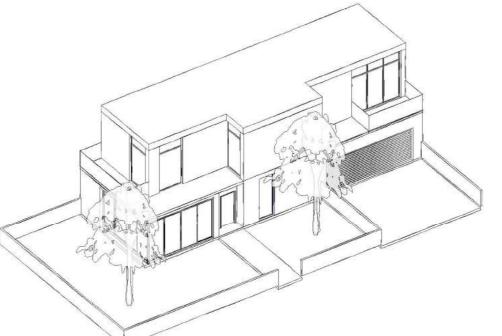


### Solar Access

6 of the 6 townhouses of this type receive a min. of 7 hours of direct sunlight at the winter solstice

#### Privacy


The arrangement of the townhouses together with the positioning of windows, use of screens and blade walls will minimise overlooking of neighbouring private open space and windows.

**Open Space**Private open space varies with a minimum of 40 sqm. A 4 x 4 m courtyard area is located to the side of the dwelling.

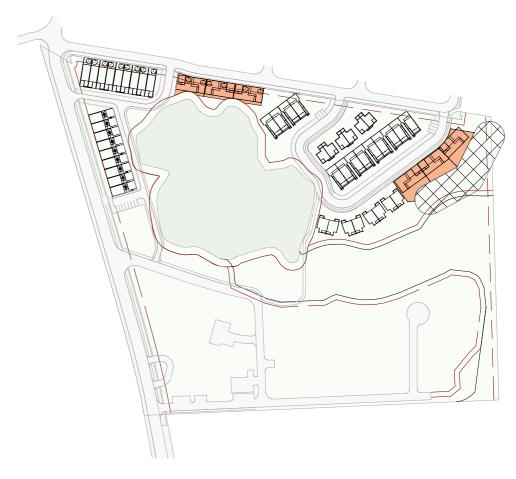

Key Plan

Indicative Locations

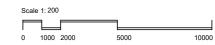



JSASTUDIO




Townhouses - Typical East-West Lots

Scales As indicated @ A3	Drawn	JSA
Project No.	Checked	JH
171101	Approved	KJ 6460
Drawing No.		Revision
SK3.03		3
Plot Date: 30-05-19 4:22:56 PM		

PRELIMINARY

# North South Lot - Alternate Layout 3 Bed/ 2.5Bath /2 Onsite Parking

Lot Size  $166m^2$ Internal Area 132m<sup>2</sup> External Courtyard area 29m<sup>2</sup>

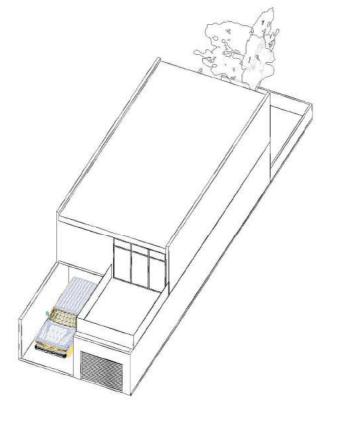


**Solar Access** 9 of the 9 townhouses of this type receive a min. of 7 hours of direct sunlight at the winter solstice


### Privacy

The arrangement of the townhouses together with the positioning of windows, use of screens and blade walls will minimise overlooking of neighbouring private open space and windows.

Open Space
Private open space of every lot of this type is 29 sqm. A 4 x 4 m courtyard area is located in the front of the dwelling.

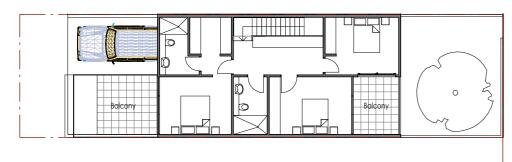


2 Level 1 Plan

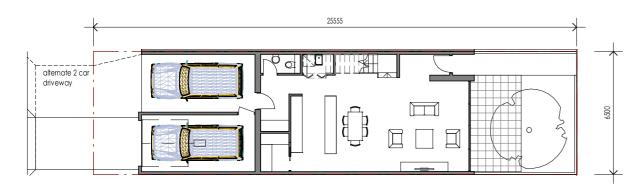

Ground Floor Plan

Indicative Layout only

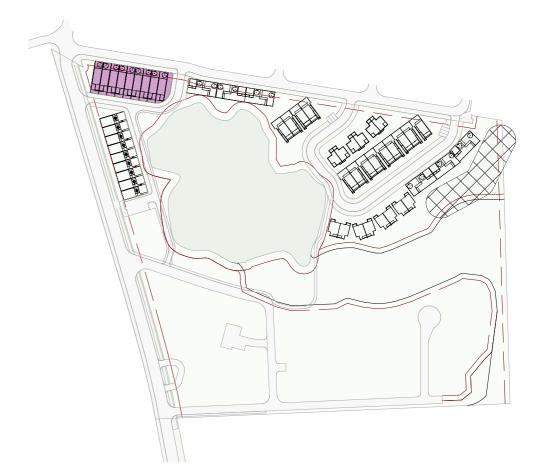

Key Plan Indicative Locations

Townhouses North South Lots - Alternate

0 1000 2000	5000	10000
Scales As indicated @ A3	Drawn	JSA
Project No.	Checked	JH
171101	Approved	

Scale 1: 200

As indicated @ A3		JSA
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PRELIMINARY

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30.11.17 02.02.18 23.03.18 13.07.18 13.07.18 23.07.18 10.04.19 21.05.19 30.05.19 ANGLICARE Village Bulli Sandon Point


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Draft - s75W Re-Submission s.75W Re-Submission

# Typical East-West Lot - Alternate Layout 3 Bed/ 2.5Bath /2 Onsite Parking

Lot Size 181m<sup>2</sup> Internal Area 132m<sup>2</sup> External Courtyard area 28m<sup>2</sup>




**Solar Access** 9 of the 9 townhouses of this type receive a min. of 4 hours of direct sunlight at the winter solstice

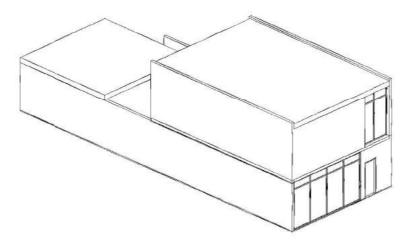
### Privacy

The arrangement of the townhouses together with the positioning of windows, use of screens and blade walls will minimise overlooking of neighbouring private open space and windows.

**Open Space**Private open space varies with a minimum of 48 sqm. A 4 x 4 m central courtyard is located in the proposed lots.

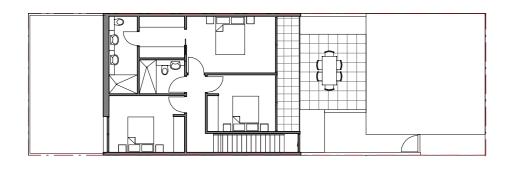

# Level 1 Plan

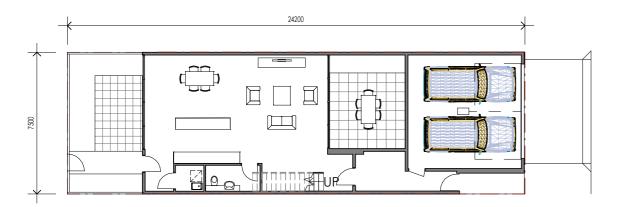

# Ground Floor Plan 1:200

Indicative Layout only

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	RESERVED. THIS WORK IS COPYRIGHT AND CANNOT BE REPRODUCED OR COPIED IN ANY FORM OR BY ANY MEANS WITHOUT THE WRITTEN	С	Issued for Information		23.03.18	Villaga Dulli
	PERMISSION OF JSA STUDIO. ANY LICENSE TO USE THIS DOCUMENT, WHETHER EXPRESSED OR IMPLIED. IS RESTRICTED TO THE TERMS OF THE	D	Issued for Information		13.07.18	Village Bulli
	AGREEMENT OR IMPLIED AGREEMENT BETWEEN JSA STUDIO AND THE	E	Issued for Information		23.07.18	
	INSTRUCTING PARTY. ALL DIMENSIONS IN MILLIMETRES U.N.O. USE FIGURED DIMENSIONS ONLY.	F	Final Draft		31.07.18	Sandon Point
	DO NOT SCALE FROM DRAWINGS. CHECK ALL DIMENSIONS ON SITE PRIOR TO CONSTRUCTION, REPORT ANY	1	s75W Submission		03.08.18	_
	DISCREPANCIES TO JSA STUDIO PRIOR TO CONSTRUCTION.	G	Issued for Information		10.04.19	For
	TO BE READ IN CONJUNCTION WITH ALL OTHER DOCUMENTS. NSW ARCHITECTS REGISTRATION BOARD REGISTERED ARCHITECTS:	2	Draft - s75W Re-Submission		21.05.19	
	KIM JONES Registration No. 6480	3	s.75W Re-Submission		30.05.19	ANGLICARE
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Alternate

Key Plan

Indicative Locations

Townhouses - Typical East-West Lots -

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0 1000 2000	5000	10000
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Project No.	Checked	JH
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PRELIMINARY

171101 Approved KJ 6460 SK3.05





29 May 2019

# **NSW Department of Planning and Environment**

320 Pitt Street

Sydney

NSW **2000** 

Att: Anthony Witherdin, Director, Regional Assessments

Re: Sandon Point Residential Redevelopment, Retirement Village Modification MP06\_0094 MOD 5

Response to Attachment A – Key Issues identified in letter dated 11 March 2019

**V** 

Dear Sir,

Please refer to the following responses to the Key Issues, to be read together with the amended plans. Issue numbers are in accordance with the numbering used in the Department's letter.

### Item 2: Density

Geraghty and Wilkies Streets Lots

Narrow building envelopes resulting in garages dominating the streetscape

The design of vehicle access to the townhouses has been revised to provide access from a common driveway, so unlike the Stockland estates, there are no longer multiple footpath crossings along the street.

Shallow lots resulting in private open space within the front setback

In relation to the Geraghty Street lots, the building envelope layout has been revised to separate the rear garage from the dwelling massing, providing private open space in the form of a courtyard between the two elements for each townhouse.

In relation to the Wilkies Street lots, the concern regarding private open space in the front setback is unfounded, due to the topography. The lots are elevated above the street as a consequence of Stockland changing the topography by excavating the road and providing retaining walls at the boundary between the Stockland estate and Precinct 2. Therefore, with a low fence along the street boundary, the private open spaces along Wilkies Street, which follow the existing topography at a higher level than the road, will have complete privacy from the public domain, while enjoying an outlook and the advantage of solar amenity throughout the day.

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### Item 4: Urban Design

The future RACF building should be redesigned to remove the proposed above ground parking. If it is demonstrated that above ground parking cannot be avoided, please outline the measures that would be implemented to minimise the visual impacts of above ground parking

It is important to note that the vehicle parking and servicing proposed for the RACF is not "above ground parking", a statement that implies an above ground parking structure. Parking for the RACF is actually 'at grade', both under and around the building. Because the vehicles using the RACF parking area also include high service vehicles and ambulances, a basement parking and servicing strategy would have resulted in an exceptionally deep excavation.

As with the ILU parking in the balance of Precinct 1, the excavation, removal and disposal of contaminated soil from the RACF area is considered undesirable from an environmental point of view. A cap and seal strategy is preferred, as it will reduce risks associated with the disturbance and transport of contaminated material, thus offering greater protection to the surrounding waterways.

The visual impact of the 'at grade' parking will be mitigated by using landscape and screening devices. Physical screen structures supporting climbing plants will be used along built edges to conceal parking areas under the RACF building, while the external areas of parking will deploy dense landscape to screen the external parking together with canopy planting where appropriate throughout the parking areas.

Regards

**Kim Jones** 

BSc. BArch.(hons1) MUrbDes. RAIA

**Principal Architect** 

JSA Studio



29 May 2019

Wollongong City Council 41 Burelli Street

Wollongong NSW **2500** 

Att: Pier Panozzo, City Centre & Major Development Manager

Re: Sandon Point Residential Redevelopment, Retirement Village Modification MP06\_0094 MOD 5

Response to Council Letter dated 18 December 2018

Dear Sir,

Please refer to the following responses to Council's concerns identified under Item 4 in Council's letter.

### Item 4. Character/scale of the development

<u>Precinct 1</u> (formerly referred to as South Precinct)

This precinct has the highest density and the overall reduction in total floor area is noted. However, the proposal is not in keeping with the character of the locality. Concerns are raised over the height. The EAR description (up to 3 storeys) is at odds with the concept architectural plans which show above ground basement parking which is not supported and not in keeping with SEPP 65 quality design principles. There is a lack of information regarding the number of visitor parking for this precinct due the potential number of units to be built within the 12 buildings. Lack of adequate visitor and resident parking will put pressure on the local road network and nearby residential roads. There also appears to be insufficient communal open space given the number of buildings/units within the development.

## Precinct 1 – Height and Basement Parking

Precinct 1 accommodates a concentration of Independent Living Units (ILU's) in a 3-storey apartment configuration arranged predominantly around communal courtyards. The design of the scheme follows SEPP65 and is consistent with the range of criteria outlined in the Apartment Design Guide (ADG). There has been a key design move to ensure the scale of the development is better suited to the established surrounding development. By maintaining the larger scale uses at the low point of the site and locating multi dwelling housing at the high point, this presents a well scaled built-form transition to the Stockland estate.

Council have commented that the proposal for Precinct 1 is "not in keeping with the character of the locality" although the precinct is separated from surrounding development by extensive open space. It is its 'own

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locality', effectively a sort of miniature peninsula between two creek catchments, with building masses generally lower than the surrounding tree canopy. The original ARV scheme was assessed and approved as part of the broader Sandon Point concept plan. By approving the concept plan, the Minister considered the development in its context and was satisfied that it would facilitate an appropriate future character. Simply, the character of the Stockland lands cannot be considered in isolation.

The scheme for Precinct 1 has, since the original application, adopted the same arrangement as the ARV concept as approved. This is relevant to the present application wherein no change is proposed to the key built form controls, as prescribed by condition A4 of the approved Concept Plan, and furthermore the current proposal represents a reduction in density and site coverage from that previously approved.

The basement parking establishes a platform on which the 3-storey apartment blocks are distributed. A consistent design approach has always shown the level of the platform to be above the existing ground level in Precinct 1, which is why the height control for the precinct is 11.4m. "Concerns are raised over the height" — however, the buildings in Precinct 1 are within the height limit, so any concern raised by Council regarding the height is unfounded.

The reason the parking level in Precinct 1 is partially protruding is to minimise the excavation and disposal of contaminated material from the site. A fully excavated parking level would require the removal and disposal of about three times as much contaminated soil. This was regarded as undesirable from an environmental point of view. A strategy of minimising the excavation, and capping and sealing the unexcavated material, is a more responsible approach to the development of the site.

The assertion that having the parking level partially above ground is "not in keeping with SEPP65 quality design principles" is not correct and is too general a statement to respond to without having recourse to the specifics of the ADG. Section 3J of the Apartment Design Guide states "On-site parking can be located underground, above ground within a structure or at grade". Nowhere in the ADG is above ground car parking ruled out.

Furthermore, although ADG Objective 3J-4 states that "protrusion of car parks should not exceed 1m above ground level", Objective 3J-6 which seeks to minimise the visual and environmental impacts of above ground car parking goes on to state that "screening, landscaping and other design elements.....should be used to integrate the above ground car parking with the façade".

Clearly, the ADG recognises that there are situations where above ground car parking is appropriate, and therefore provides design guidance as to its treatment. However, in Precinct 1 the intention is to build up the existing ground level along the north, west and east edges of the parking platform, such that its presence is fully integrated into the perimeter landscape grades along these edges. It is evident that such a strategy is the most effective form of screening possible. Unless one is circulating along the southern edge of the precinct, an area already screened by mature vegetation along the northern edge of Tramway Creek, the



presence of a parking level would be completely imperceptible. The landscape levels along the southern edge of the car park are not built up. However, they are concealed by a balance of lobbies and heavy planting in accordance with ADG recommendations for above-ground car parking structure.

<u>Precinct 3</u> (formerly referred to as Ocean View Precinct)

Council does not support the proposed dwellings in the south eastern section of this precinct abutting the aboriginal archaeological site. Proposed lots to the east appear to have insufficient lot depth of less than 25m as required by Council's controls. There is also expected to be heritage impacts due to insufficient buffer between proposed allotments and the archaeological site.

Precinct 3 – Interface with Archaeological Site

The depth of the lots has been increased in the group abutting the aboriginal archaeological site due to the realignment of the loop road serving Precinct 3. As shown, the new lots do not encroach on recommended buffer zone.

Regards

**Kim Jones** 

BSc. BArch.(hons1) MUrbDes. RAIA

**Principal Architect** 

JSA Studio