



MODIFICATION 1 TO APPROVED CONCEPT PLAN MP10_0068 (Commercial Tower Envelope)

ELECTRICAL SERVICES INFRASTRUCTURE - SITE PLAN

SCHEME: PA-2020-SCH21


DATE: July 2020

SCALE: 1:500 @ A0

JOB NO: D6727

DWG NO: SDC-ELE-E01

REV:A

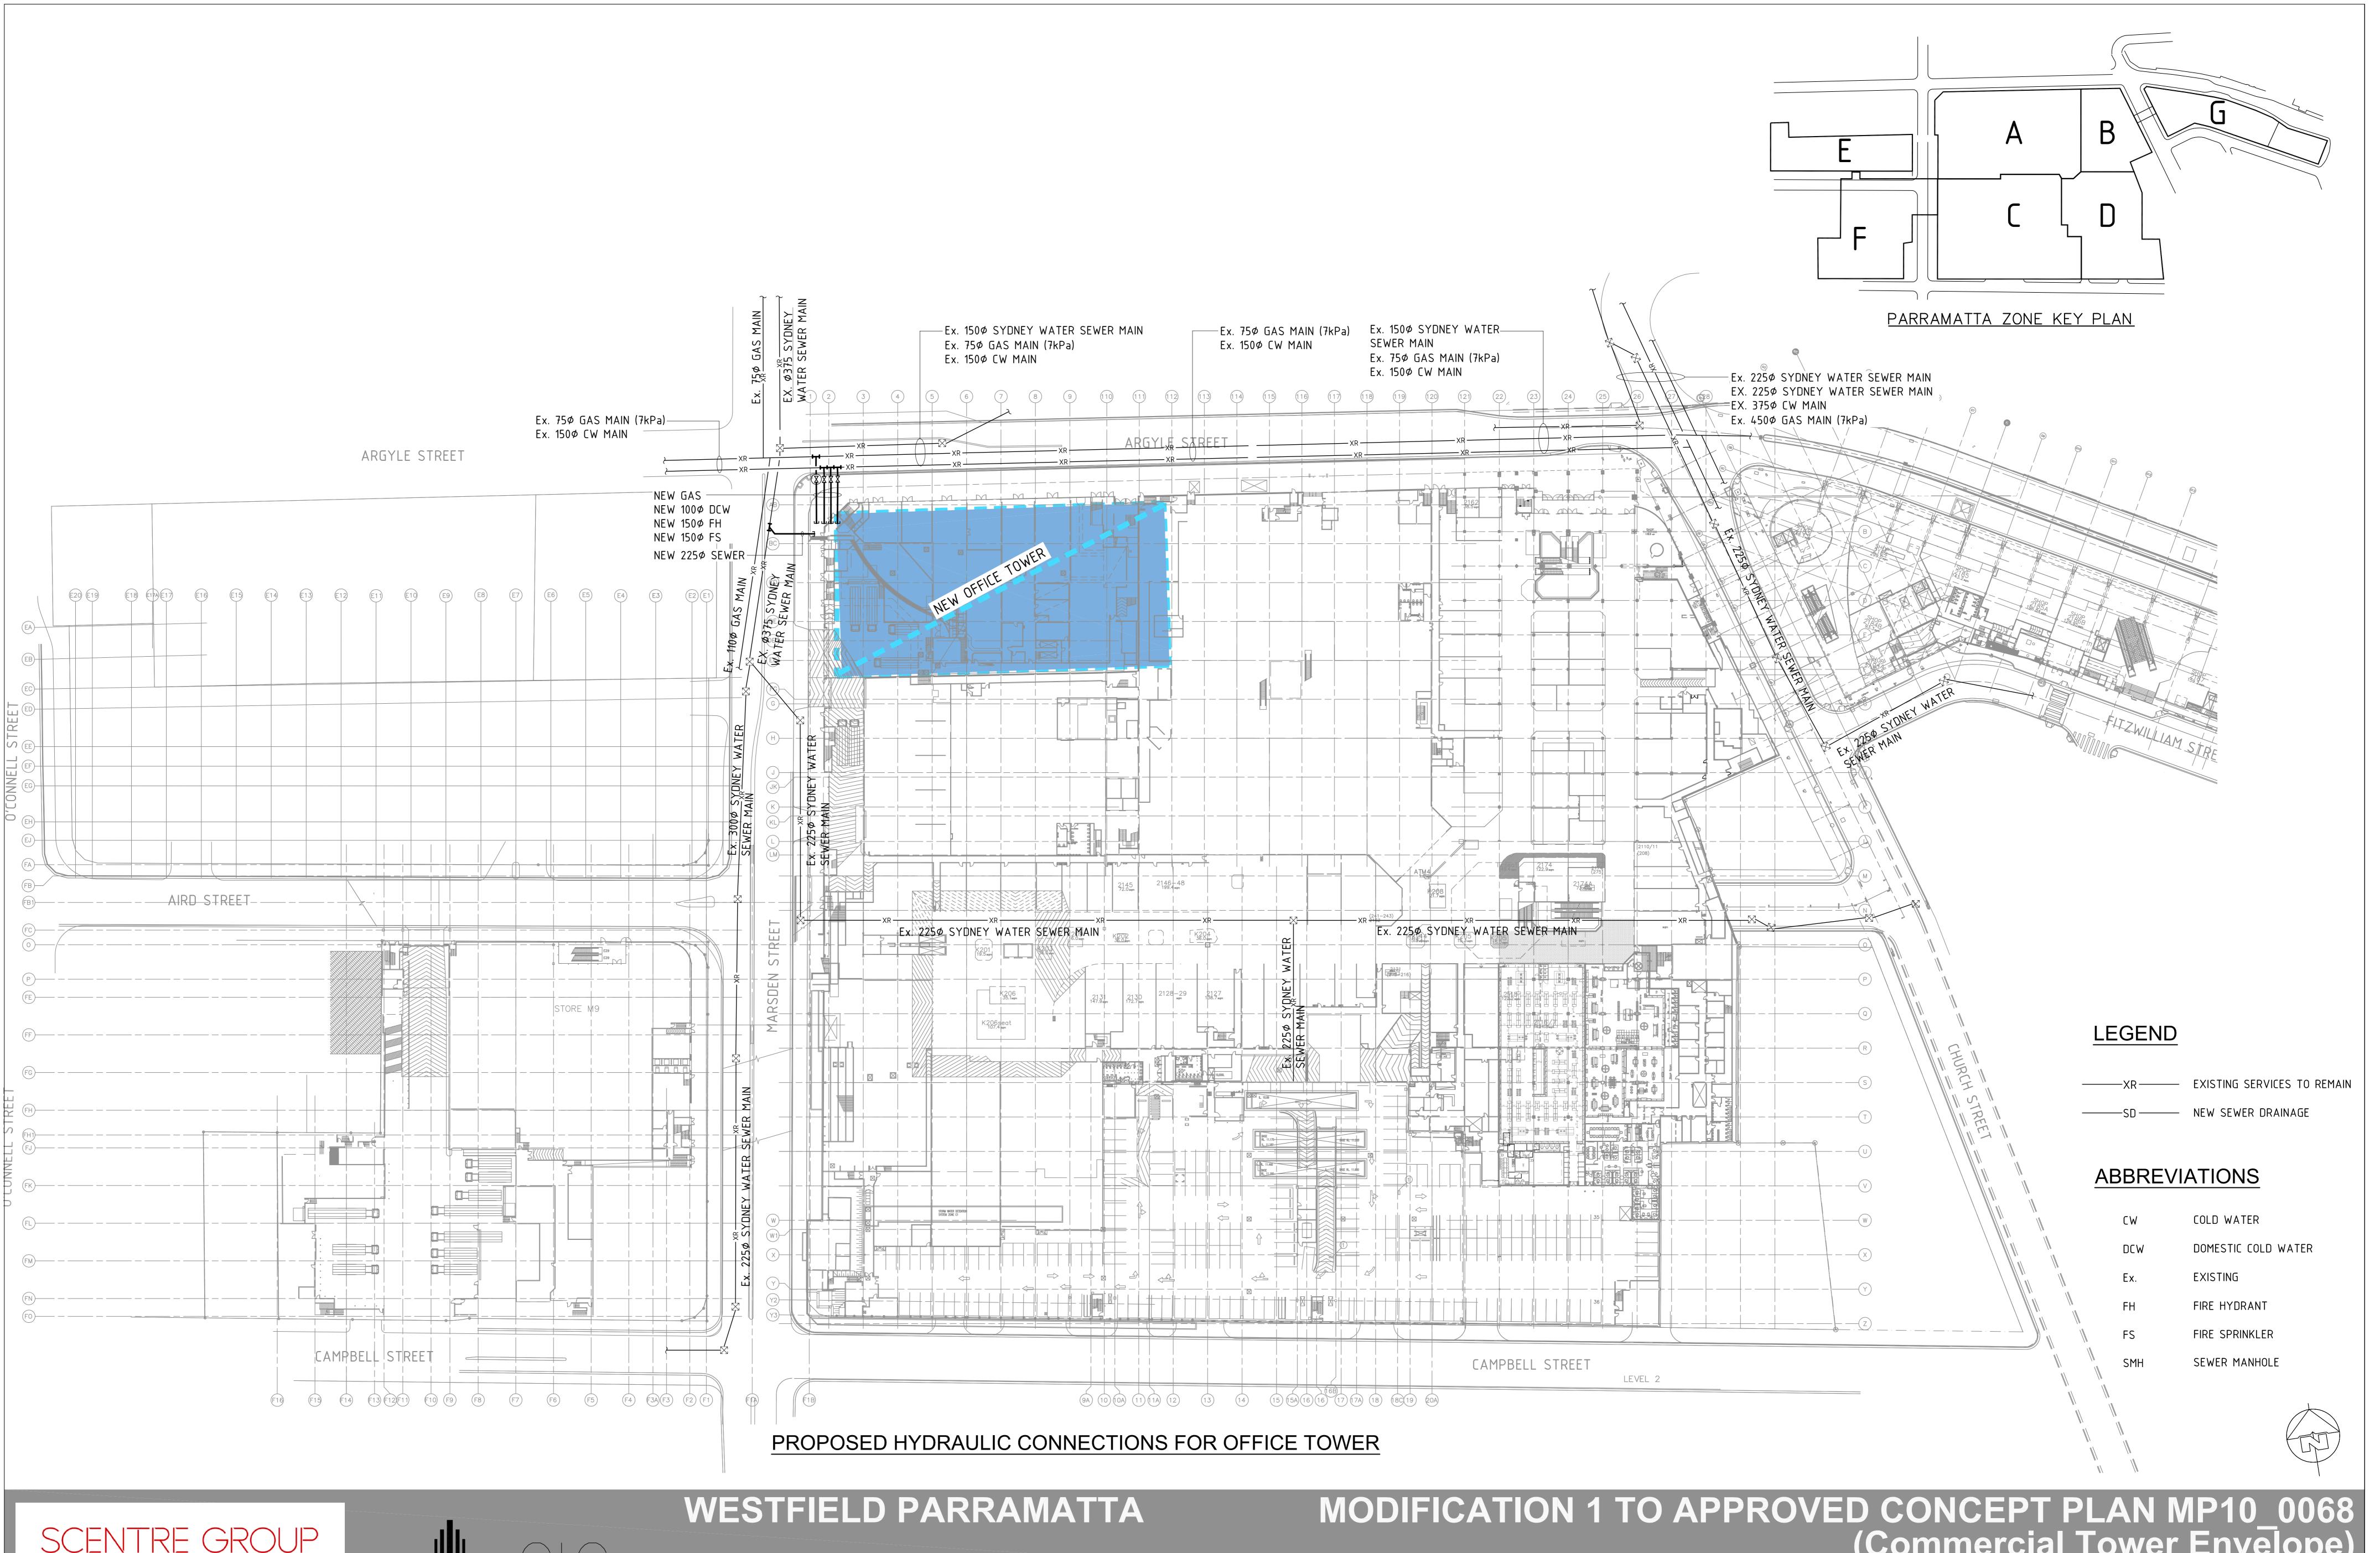





MODIFICATION 1 TO APPROVED CONCEPT PLAN MP10_0068 (Commercial Tower Envelope)

HYDRAULIC SERVICES INFRASTRUCTURE - SITE PLAN

SCHEME: PA-2020-SCH21

DATE: June 2020

SCALE: 1:500 @ A0

DWG NO: SDC-HYD-H01 JOB NO: D6727


REV:A



WESTFIELD PARRAMATTA OFFICE TOWER D6727 HYDRAULIC & ELECTRICAL SERVICES MEMORANDUM

People Protecting People



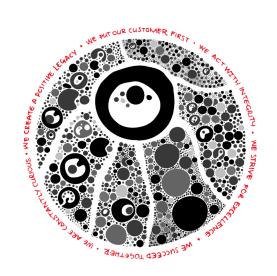

Creating extraordinary places, connecting and enriching commui



DOCUMENT HISTORY

Revision	Date	Filename	D6727-SDC-PAR-ENS-MEM-001-A-WESTFIELD PARRAMATTA OFFICE TOWER-Hydraulic & Electrical Services Memo				
А	Date	Description	Issued to Department of Planning NSW				
	10.07.2020		Prepared by	Checked by	Approved by		
		Name	Natalia Semenova	Neel Mistry	Matthew Preece		
		Date	10.07.2020	10.07.2020	10.07.2020		
Revision	Date	Filename					
TBC	Date	Description					
			Prepared by	Checked by	Approved by		
		Name					
		Date					
Revision	Date	Filename					
TBC	Date	Description					
			Prepared by	Checked by	Approved by		
		Name					
		Date					
Revision	Date	Filename					
TBC	Date	Description					
			Prepared by	Checked by	Approved by		
		Name					
		Date					

Date: 10.07.2020



1 BACKGROUND INFORMATION

This memo is in relation to the attached 'Infrastructure Concept Plan Drawings' for the proposed Section 75W Modification (MOD1) to the Approved Commercial Tower Building Envelope Concept (Major Project MP10_0068 Westfield Shopping Centre, Parramatta).

Infrastructure Concept Plan Drawings:

- **D6727-SDC-HYD-H01** Hydraulic services indicating Sewer, Water, Fire Services and Gas supply to the proposed office tower.
- **D6727-SDC-ELE-E01** Electrical services indicating High Voltage and Communications supply to the proposed office tower.

The proposed Section 75W modification proposes relocation of the commercial tower to the corner of Argyle and Marsden Streets, above the existing retail podium, providing a larger floor plate and taller building, extending the height to approximately 220 metres above ground. At this stage the architectural design of the office tower has not yet been finalised.

2 PROPOSED WORKS / RECOMMENDATIONS

The concept plans include the following general future provision for Hydraulic and Electrical infrastructure to service the office tower:

2.1 Sewer

Sewer connection is proposed from the nearest available 375mm Sydney Water sewer main in Marsden Street. A new side line sewer connection proposed to be 225mm diameter, to provide a connection of suitable capacity for the office tower.

2.2 Water

Water connections are proposed to the existing Sydney Water watermain in the Argyle Street footpath adjacent to the proposed office tower location. Connections will supply domestic cold water (100mm diameter connection) and the fire services consisting of 150mm connections for Fire Hydrants and Fire Sprinklers.

Note that the final servicing arrangements will be confirmed upon receipt of a Sydney Water Section 73 Subdivider/Developer Notice of Requirements after a formal application once planning approval has been obtained.

2.3 Gas

Gas services are provided to the existing centre by several connections from the Jemena Gas Network in the streets adjacent to the Westfield Parramatta site.

Gas will be supplied to the office tower with a new connection to the existing 7kPa gas main located in the footpath in Argyle Street. Scentre Design & Construction have notified Jemena of this proposal via correspondence on the 20th April 2018.

2.4 Electrical

The existing shopping centre is serviced by nine substations located in the Westfield Parramatta shopping centre footprint (all owned and maintained by Endeavour Energy). The existing commercial building is also supplied from one of these substations.

The proposed new office tower would require additional electrical substations on site. Endeavour Energy have advised the new electrical demand from the extension would be met by supply from the West Parramatta Zone Substation.

Date: 10.07.2020 Page **3** of **4**

WESTFIELD PARRAMATTA OFFICE TOWER Hydraulic & Electrical Services Memo D6727-SDC-PAR-ENS-MEM-001



2.5 Telecommunications

The telecommunication service is provided to the existing centre by means of copper and fibre optic service from Telstra's network in the streets.

The new office tower will be serviced by NBNCo via their broadband fibre optic network.

As mentioned above as the architectural design for the office tower has not yet been finalised detailed assessments of capacity cannot be finalised, nor the formal applications can be submitted to establish the exact servicing requirements from the authorities until these are determined.

3 REFERENCES

- D6727-SDC-HYD-H01 HYDRAULIC SERVICES INFRASTRUCTURE CONCEPT PLAN
- D6727-SDC-ELE-E01 ELECTRICAL SERVICES INFRASTRUCTURE CONCEPT PLAN

Date: 10.07.2020



WESTFIELD PARRAMATTA OFFICE TOWER D6727 STORMWATER SERVICES MEMORANDUM

People Protecting People ***





Creating extraordinary places, connecting and enriching communities.



DOCUMENT HISTORY

Revision	Date	Filename	D6727-SDC-PAR-ENS-MEM-002-A-WESTFIELD PARRAMATTA OFFICE TOWER-Stormwater Services Memo				
А	Date	Description	Issued to Department of Planning NSW				
	10.07.2020		Prepared by	Checked by	Approved by		
		Name	Natalia Semenova	Neel Mistry	Matthew Preece		
		Date	10.07.2020	10.07.2020	10.07.2020		
Revision	Date	Filename					
TBC	Date	Description					
			Prepared by	Checked by	Approved by		
		Name					
		Date					
Revision	Date	Filename					
TBC	Date	Description					
			Prepared by	Checked by	Approved by		
		Name					
		Date					
Revision	Date	Filename					
TBC	Date	Description					
			Prepared by	Checked by	Approved by		
		Name					
		Date					

1 BACKGROUND INFORMATION

Date: 10.07.2020 Page **2** of **3**

lssue: A

WESTFIELD PARRAMATTA OFFICE TOWER Stormwater Services Memo D6727-SDC-PAR-ENS-MEM-002



This memo is in relation to the attached 'Stormwater Management Concept Plan Drawing' (HCSW01) for the proposed Section 75W Modification (MOD1) to the Approved Commercial Tower Building Envelope Concept (Major Project MP10_0068 Westfield Shopping Centre, Parramatta).

The proposed Section 75W modification propose relocation of the commercial tower to the corner of Argyle and Marsden Streets, above the existing retail podium, providing a larger floor plate and taller building, extending the height to approximately 220 metres above ground. At this stage the architectural design of the office tower has not yet been finalised.

The concept plans include potential for future provision of a landscaped rooftop terrace on the level 6 carpark (below the tower) with space for cafes, outdoor dining and the like. There is also potential for a ground level commercial tower lobby and reconfigured retail tenancies along Argyle Street. The proposal includes upgrades to the external façade along Argyle Street and Church Street.

2 PROPOSED WORKS / RECOMMENDATIONS

The 'Stormwater Management Concept Plan' indicates that as the proposal is a relocation within the footprint of the existing shopping centre the catchment area remains unaltered. The entire site is already services with existing on-site detention systems, OSD's (as listed under Note 2 on drawing HCSW01). Stormwater drainage from the commercial tower will be directed to the existing internal onsite detention tanks.

Therefore, the proposed commercial development will not represent any increase upon the existing site stormwater permitted site discharge, PSD, to the council system.

3 REFERENCE

- HCSW01 - STORMWATER MANAGEMENT CONCEPT PLAN DRAWING

Date: 10.07.2020 Page **3** of **3**

1.- PROJECT DESCRIPTION. THE PROPOSED WORK ESSENTIALLY COMPRISE INTERNAL/VERTICAL EXTENSION AND ALTERATION.

THE PROPOSED NEW WORK INCLUDE: LEVEL 6 NEW RETAIL AREA

- NEW CARPARK LEVEL - NEW ROOF

NEW OFFICE TOWER

ALL OF THESE WORKS REPRESENT (PROPOSED) NO ADDITIONAL INCREASE FLOOR AREA.

2.- EXISTING STW DRAINAGE.

THE EXISTING SWD COMPOSE A NUMBER OF INTERNAL STORMWATER DRAINAGE POINTS, INCLUDING ROOF DRAINAGE, DRAINING TO THE A NUMBER OF EXISTING STORMWATER OSD TANKS.

3.- PROPOSED.

ALL EXISTING DP's WILL BE EXTENDED TO RECEIVE THE STORMWATER FROM ALL NEW ROOF AND IMPERVIOUS AREAS AND WILL NOT AFFECT THE CURRENT PSD.

IN ADDITION TO THE ABOVE THE PROPOSED STW SYSTEM WILL INCLUDE:

- 50,000LTS OF RAINWATER HARVESTING FOR TOILET FLUSHING.

4.- SUMMARY.

THE PROPOSED DEVELOPMENT WILL NOT REPRESENT INCREASE ON

THE SITE STW PSD TO THE COUNCIL SYSTEM.

