


Macquarie Park Station Waterloo Road

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PA02-002 Basement Level 002 Plan

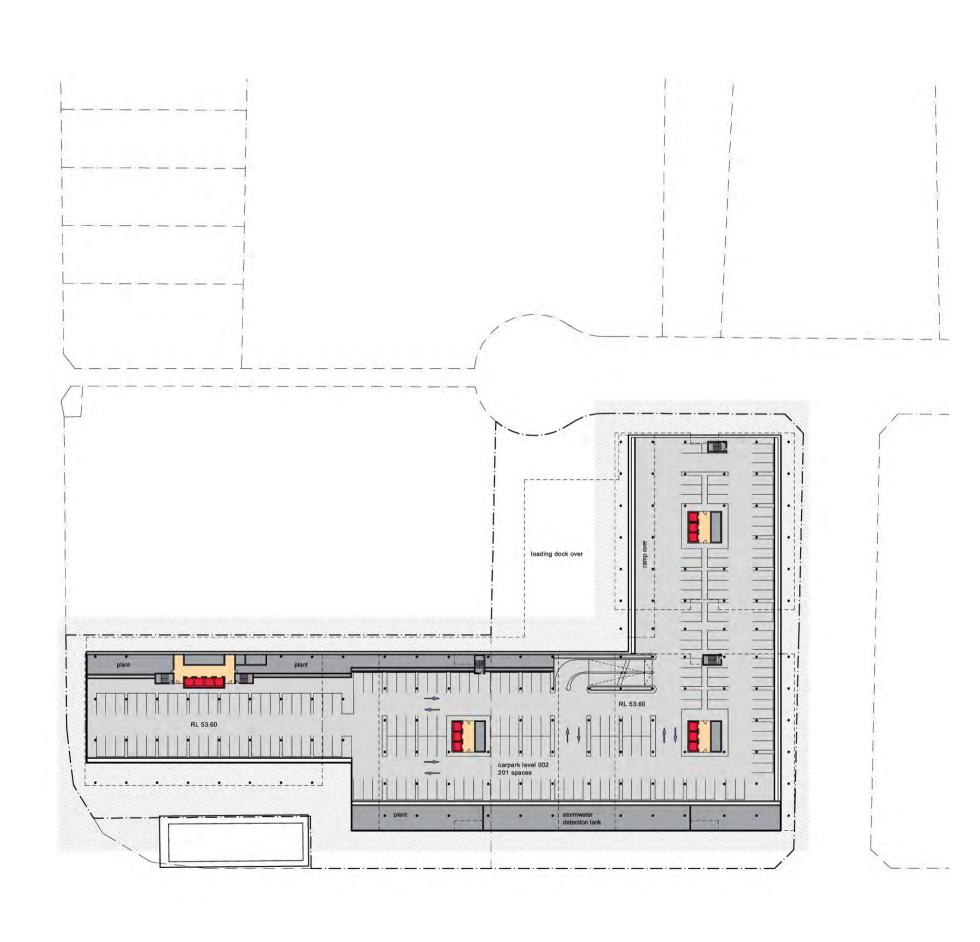






Macquarie Park Station Waterloo Road

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PA02-003 Basement Level 003-005 Plan





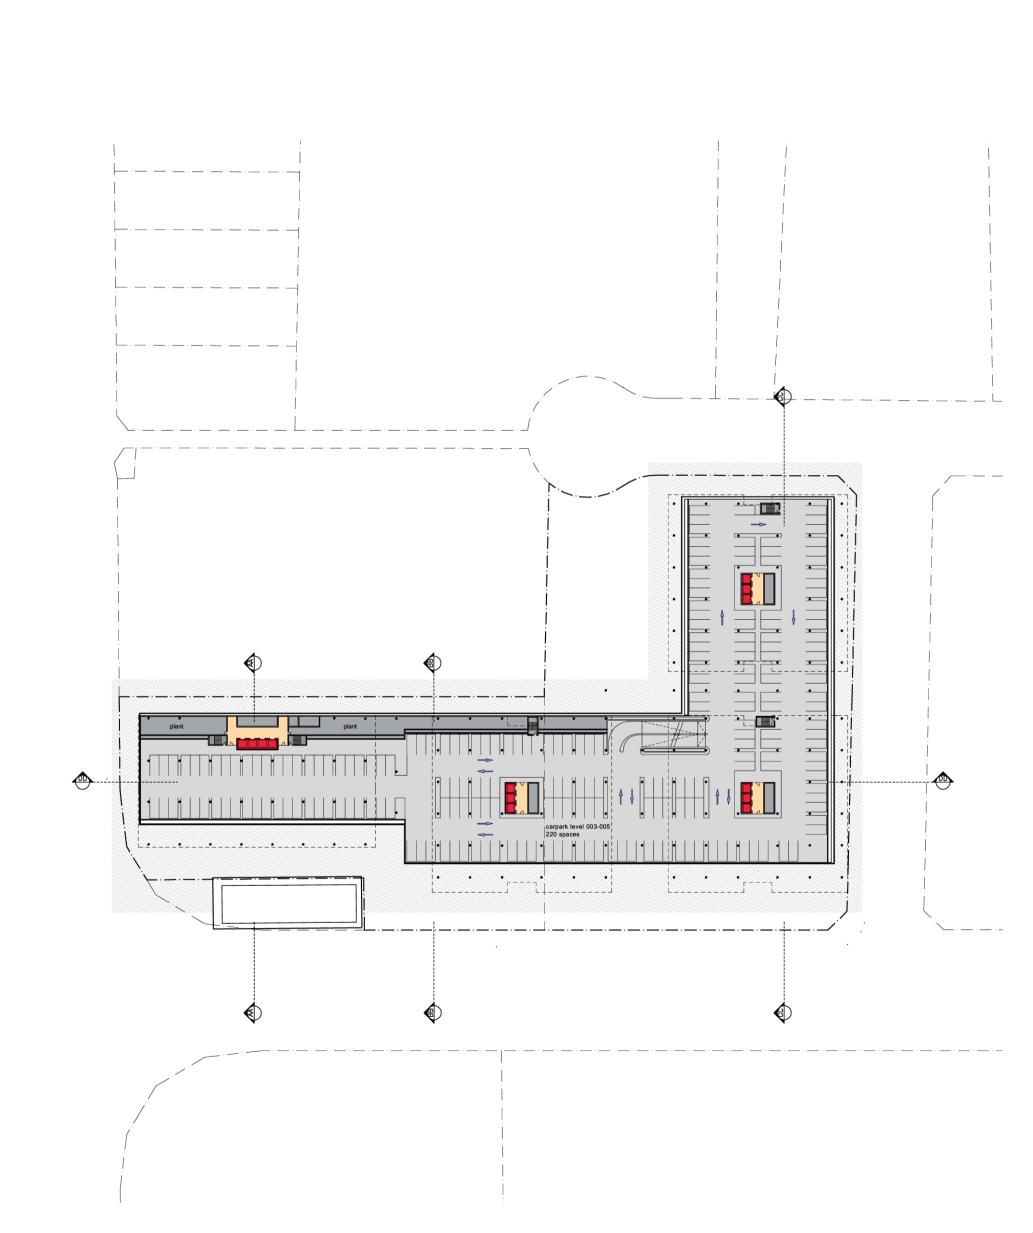


Macquarie Park Station Waterloo Road

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PA02-006 Basement Level 006 Plan





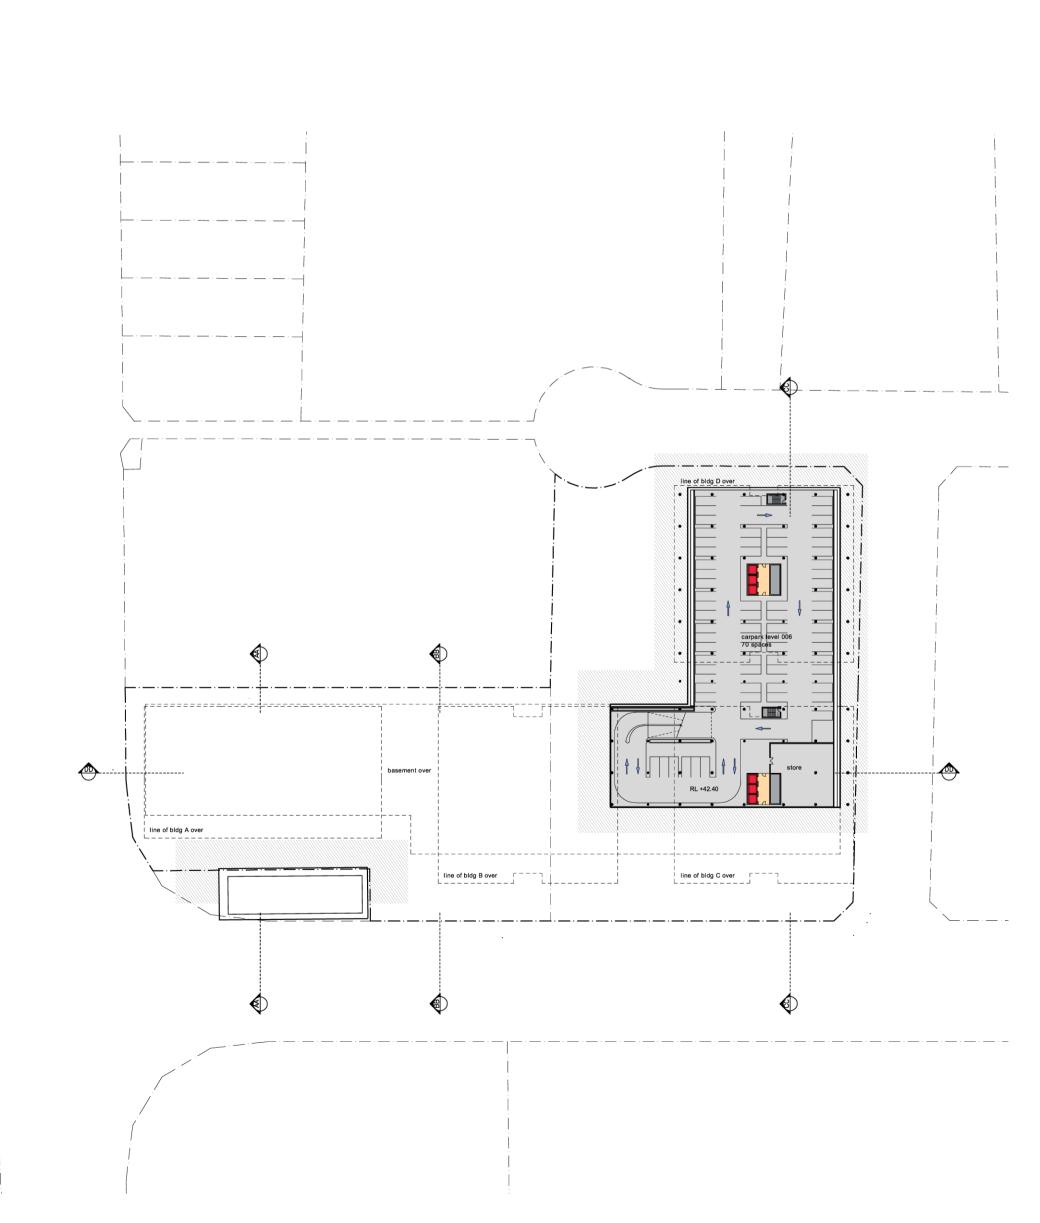

Macquarie Park Commerce Centre Macquarie Park Station

Waterloo Road

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PA02-00 Ground Level Plan







Macquarie Park Station Waterloo Road

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PA02-01Typical Level Plan








Macquarie Park Station Waterloo Road

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PA02-10 Upper Level Plan





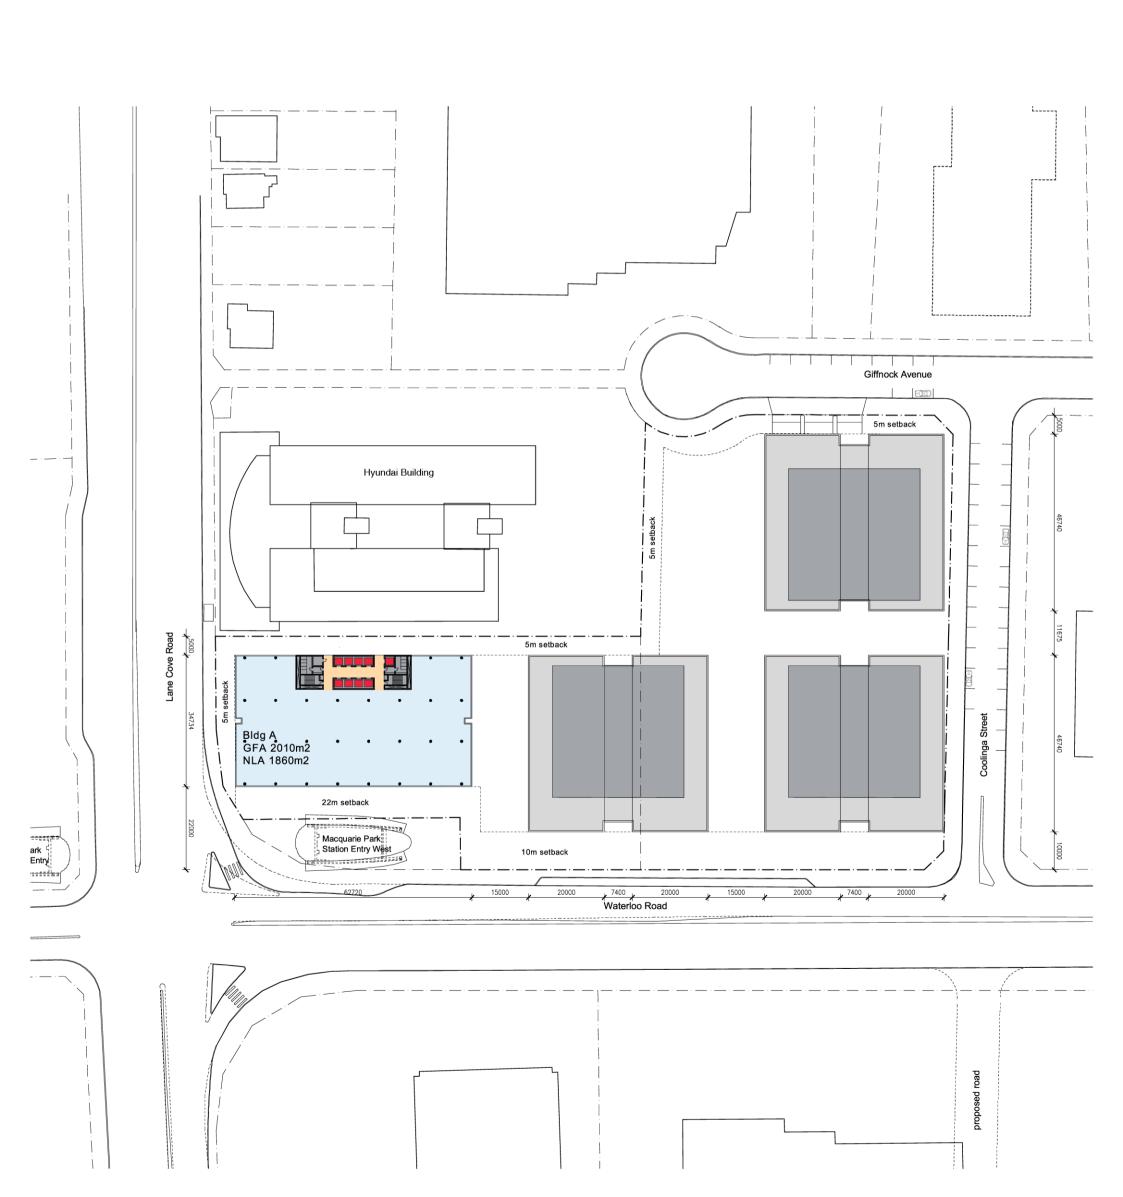


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PA02-20 Roof Plan





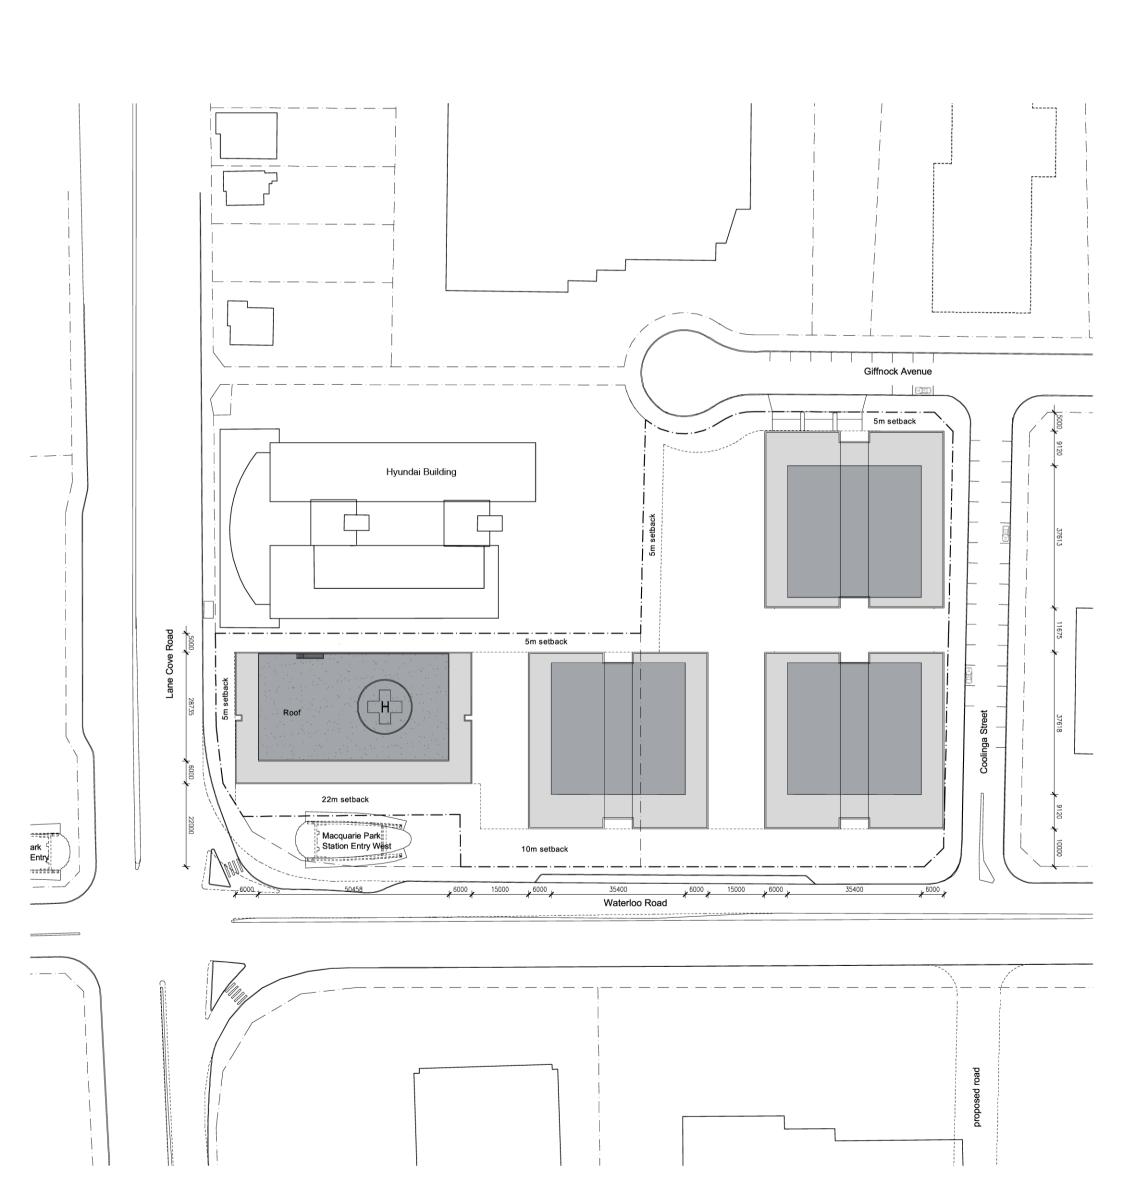


Macquarie Park Station Waterloo Road

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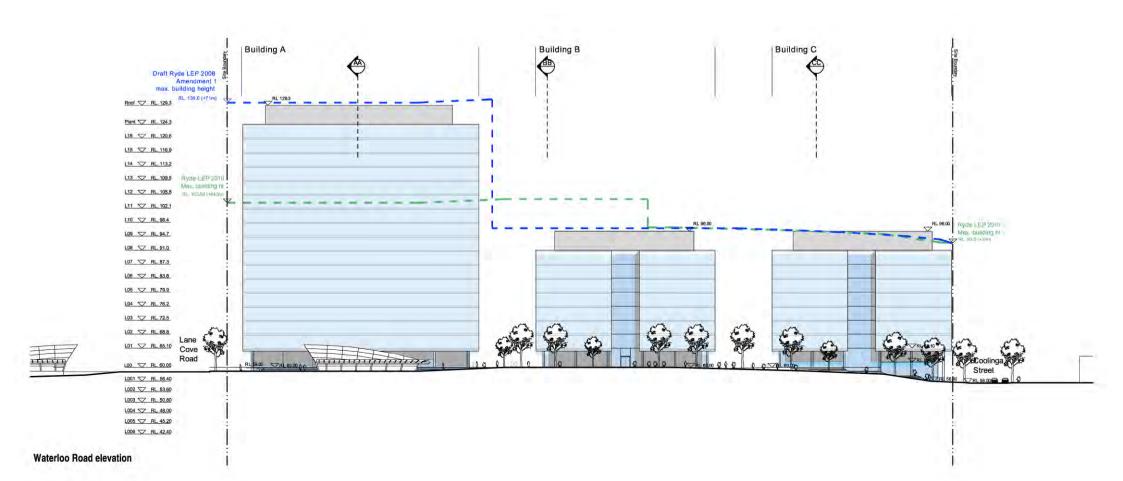
PA05-01 Elevations Waterloo Road & Coolinga Street

Scale 1:1000



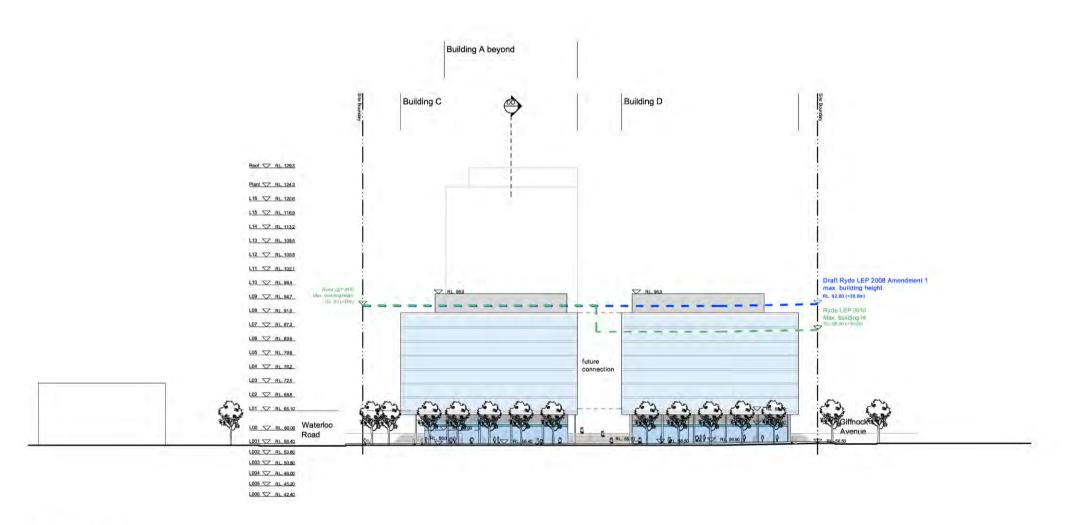

Coolinga Street elevation






Macquarie Park Station Waterloo Road


Architectural Design Statement S10758 September 2010

PA05-02 Elevations Lane Cove Road and Giffnock Avenue

Scale 1:1000

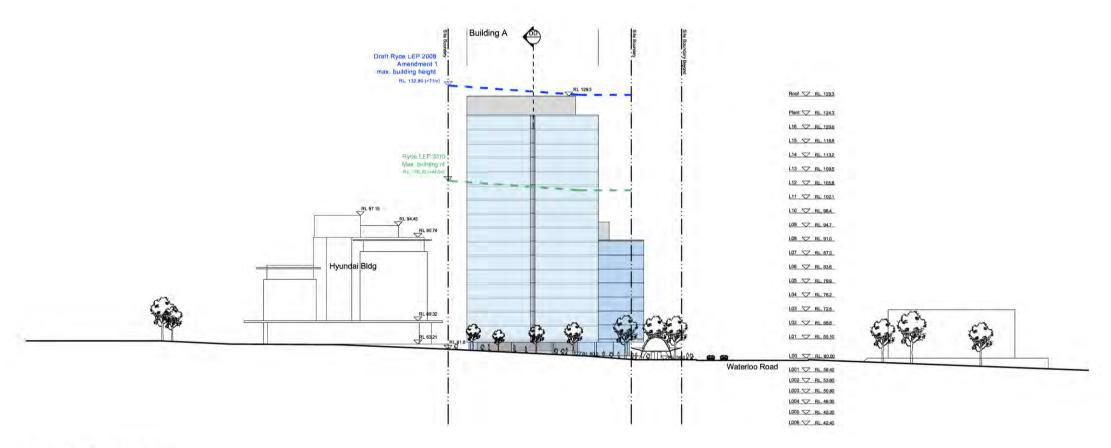

Lane Cove Road elevation

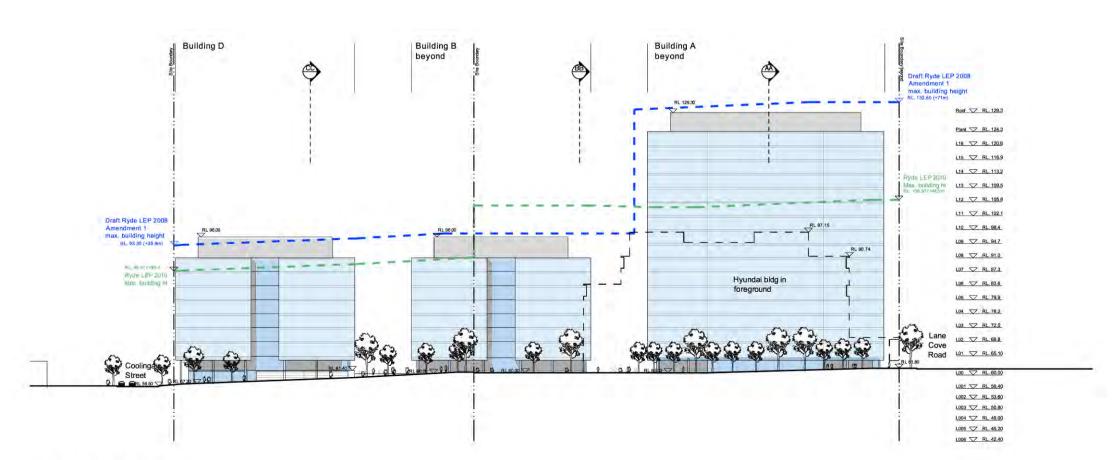




Macquarie Park Station Waterloo Road

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PA06-01 Section AA

Scale 1:500

Property Stratum
 10-15m recommended radial distance from tunnel (refer to Parsons Brinckerhoff report)




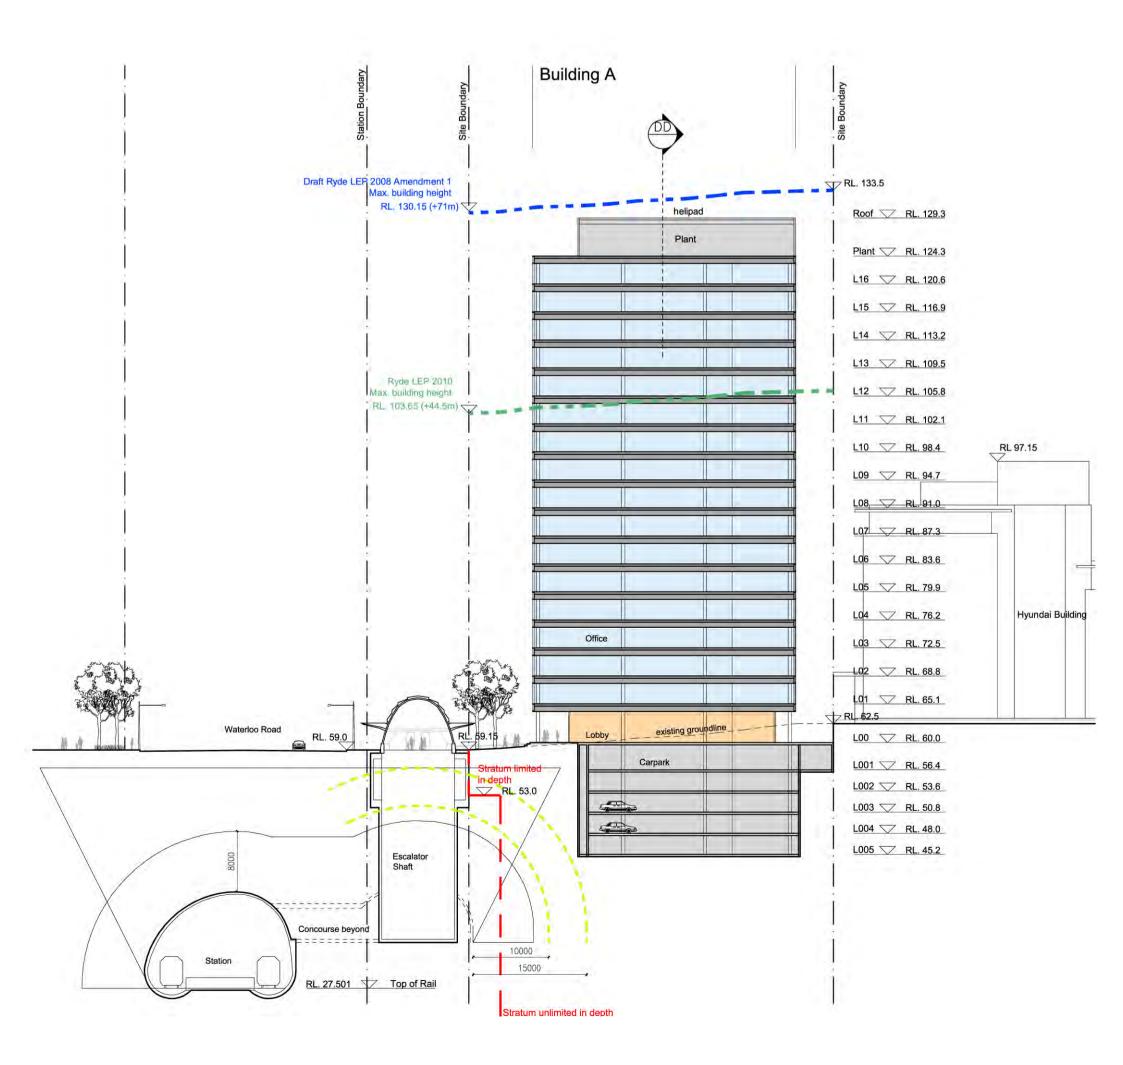

Macquarie Park Station Waterloo Road

Architectural Design Statement S10758 September 2010

PA06-02 Section BB

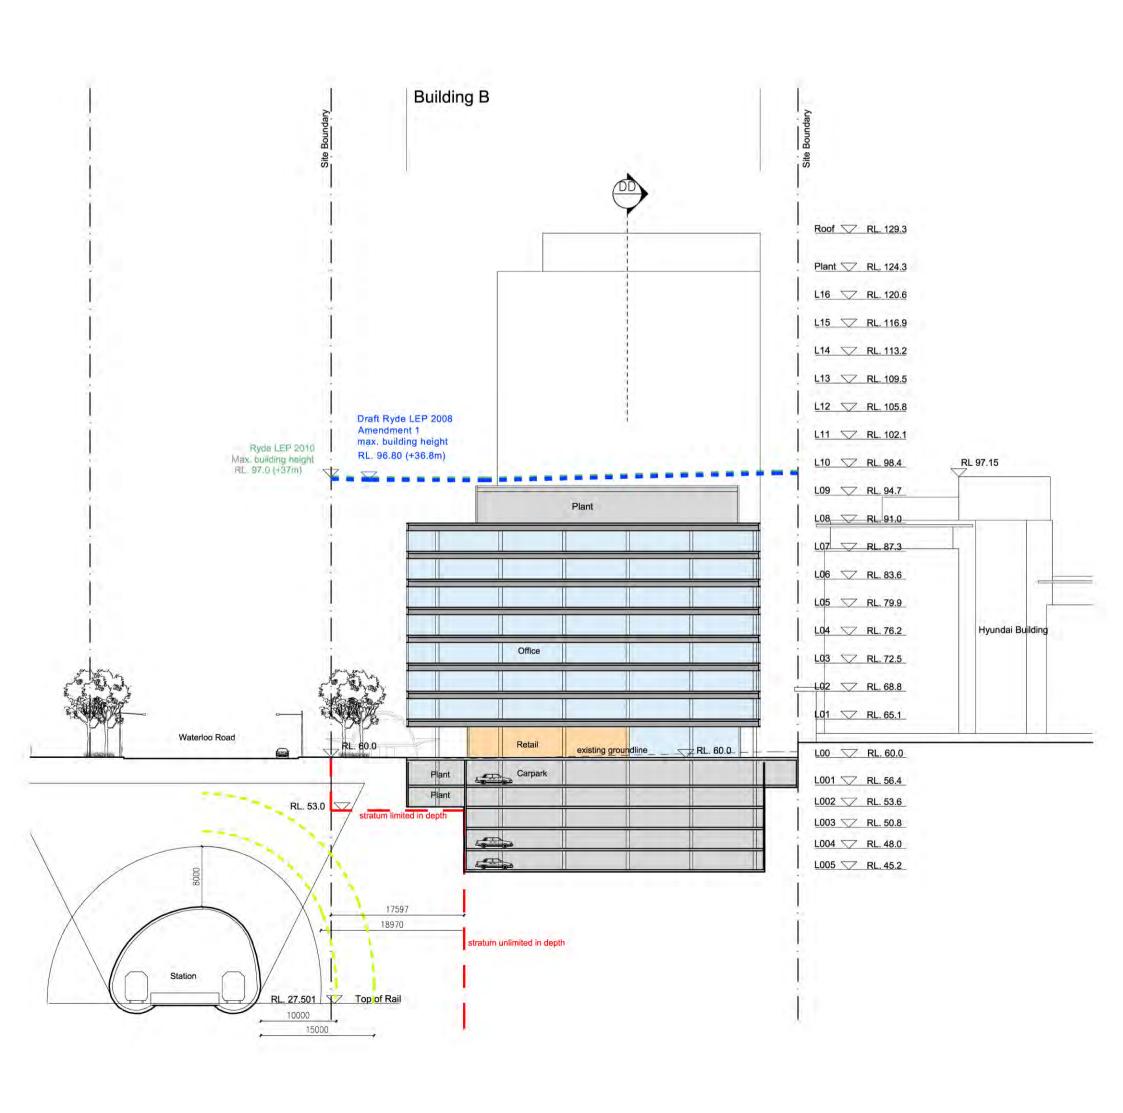




Macquarie Park Station Waterloo Road

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PA06-03 Section CC




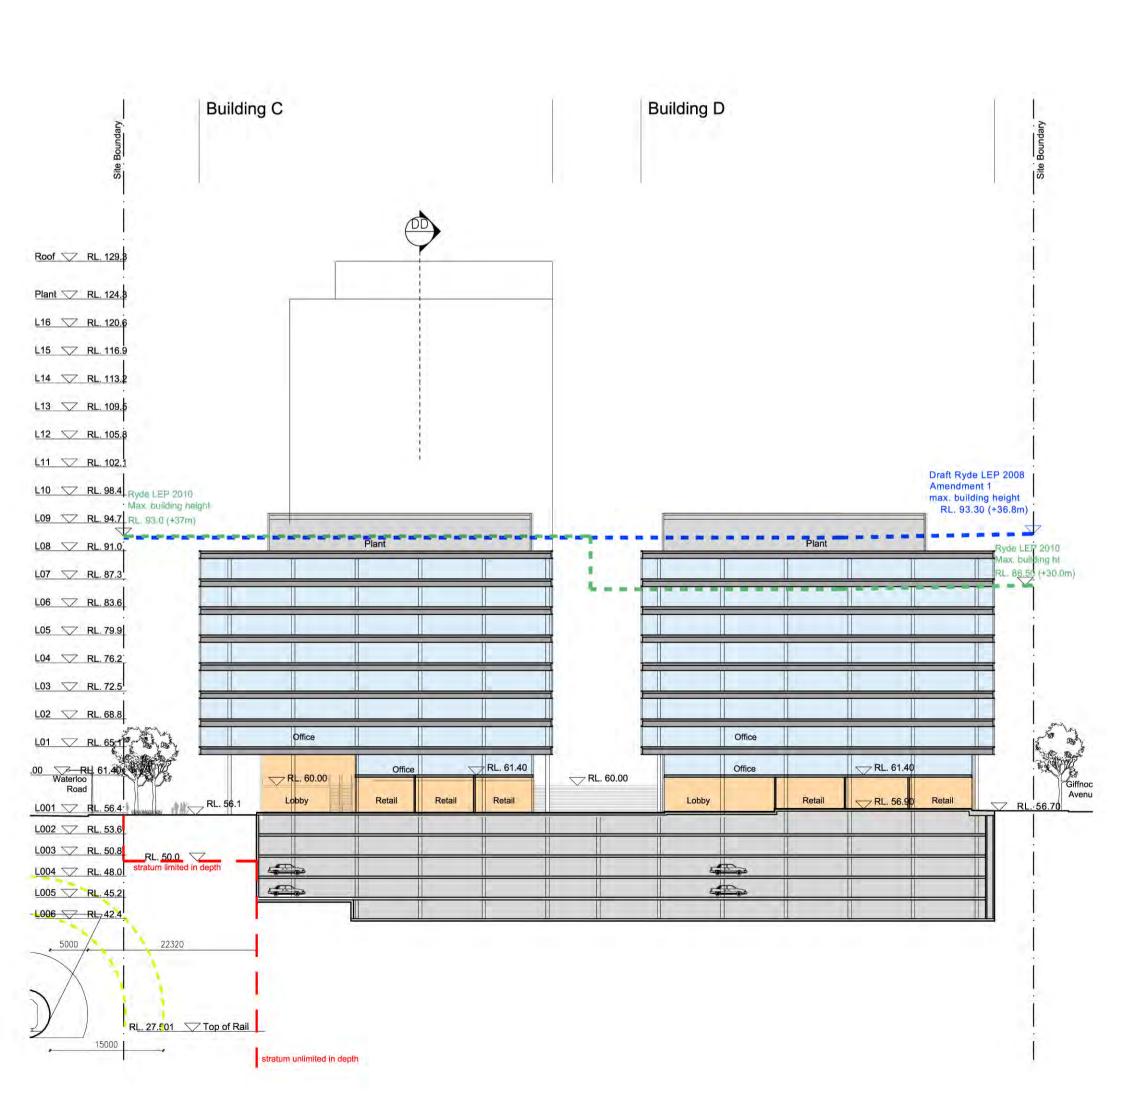

Macquarie Park Station Waterloo Road

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PA06-04 Section DD



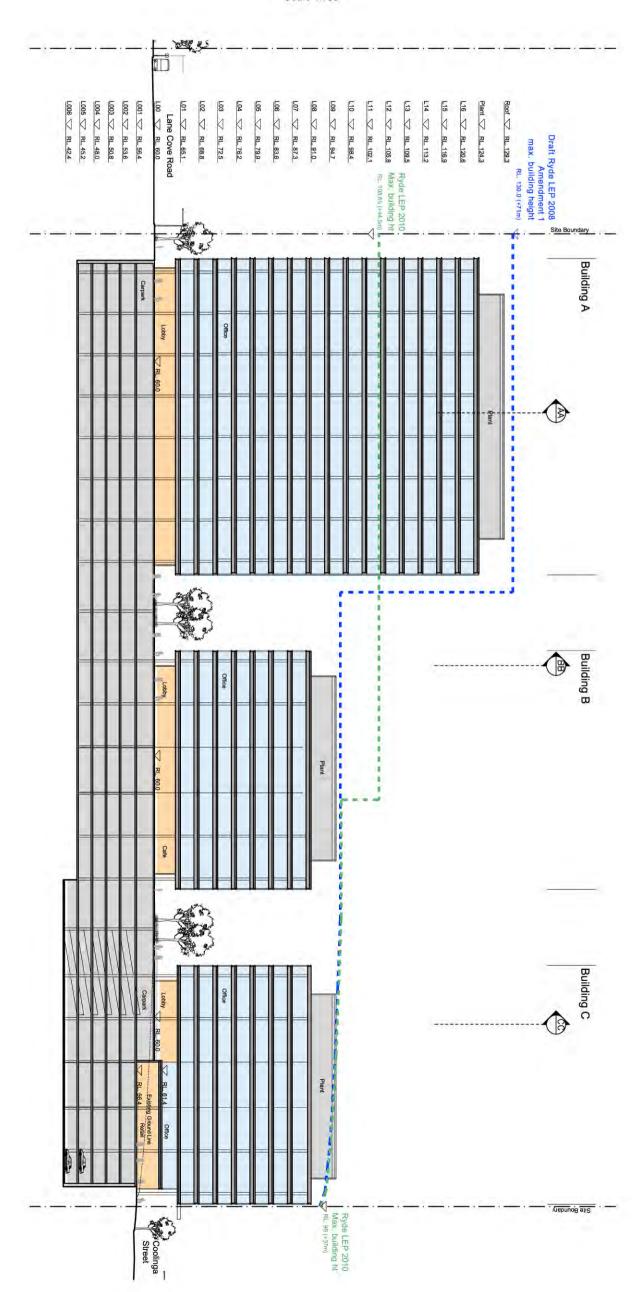

SUBTOTAL	Level B006	Level B005	Level B004	Level B003	Level B002	Level B001	Ground 00	Level 01	Level 02	Level 03	Level 04	Level 05	Level 06	Level 07	Level 08	Level 09	Level 10	Level 11	Level 12	Level 13	Level 14	Level 15	Level 16	Level 17 Plant	Level		DEVELOPMENT
	3000	3000	3000	3000	3000	varies	varies	3700	3700	3700	3700	3700	3700	3700	3700	3700	3700	3700	3700	3700	3700	3700	3700	5000	Floor Height	Floor to	
	Basement	Basement	Basement	Basement	Basement	Basement/Lower Gr	Low Rise	Low Rise	Low Rise	Low Rise	Low Rise	Low Rise	Low Rise	Low Rise	High Rise/Roof	High Rise	Roof	Location									
	Parking	Parking	Parking	Parking	Parking	Loading /Parking/Retail/Lobby	Lobby/Retail/Commercial	Commercial	Commercial/plant	Commercial	Plant	Use															
1042	70	220	220	220	201	111																			Numbers	Parking	
54055	6563	8873	8873	8873	9743	11130																			GBA (m2)		
29760							0	1860	1860	1860	1860	1860	1860	1860	1860	1860	1860	1860	1860	1860	1860	1860	1860		NLA (m2)	Commercial	BLDG A
747							747																		GFA (m2)	Retail	
33688						100	1428	2010	2010	2010	2010	2010	2010	2010	2010	2010	2010	2010	2010	2010	2010	2010	2010	0	GFA (m2)		
14385							735	1950	1950	1950	1950	1950	1950	1950											NLA (m2)	Commercial	BLDG B
276							276																		GFA (m2)	Retail	
16085						100	1460	2075	2075	2075	2075	2075	2075	2075	0										GFA (m2)		
14385						0	735	1950	1950	1950	1950	1950	1950	1950											NLA (m2)	Commercial	BLDG C
390						390	0																		GFA (m2)	Retail	
16615						865	1225	2075	2075	2075	2075	2075	2075	2075	0										GFA (m2)		
15200						0	1550	1950	1950	1950	1950	1950	1950	1950			-	-	-	-	-	-	-	-	NLA (m2)	Commercial	BLDG D
439						439																			GFA (m2)	Retail	
16980						795	1660	2075	2075	2075	2075	2075	2075	2075	0										GFA (m2)		

TOTAL DEVLOPMENT				73730 1852 83368
Carparking Summary (Macquarie Park Corridor DCP 2010)	Park Corridor DCP 2010)	Bicycle parking Summary (Macquarie Park Corridor DCP 2010)		Definitions (Ryde LEP 2010)
1 car space per 80sqm GFA	1042	1 per 200sqm Commercial GFA	417	Gross Floor Area (GFA): means the sum of the floor area of each floor of a building measured from the internal face of external walls, or from the internal face of
(excl. couriers)		1 per 750sqm GFA for Visitors 1 per 300sqm floor area retail employees	111	walls separating the building from any other building, measured at a height of 1.4 metres above the floor, and includes: (a) the area of a mezzanine, and (b) habitable croms in a basement or an attic and
Proposed Carpark Efficiency				(c) any shop, auditorium, cinema, and the like, in a basement or attic, but excludes:
(Typical Level)	40sqm/car	1 per 500sqm floor area retail shoppers	4	(d) any area for common vertical circulation, such as lifts and stairs, and(e) any basement:
Legend		Total bikes	538	 (i) storage, and (ii) vehicular access, loading areas, garbage and services, and (f) plant rooms, lift towers and other areas used exclusively for mechanical services or ducting, and (g) car parking to meet any requirements of the consent authority (including access to that car parking), and (h) any space used for the loading or unloading of goods (including access to it), and
	High-rise Commercial			(i) terraces and balconies with outer walls less than 1.4 metres high, and(j) voids above a floor at the level of a storey or storey above.

Commercial Retail NLA (m2) GFA (m2) GFA (m2)

Plant

Basement

Change Facilities

Lobby/Retail

Low-rise Commercial


Location Plan



Concept Master Plan



Soil Depth

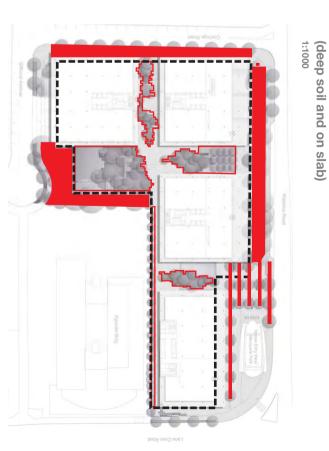

- Extent of basement under
- Extent of Deep Soil (on natural ground). Includes porous pavement soil volume availble for tree growth. Approximate 2,443m2
- Extent of soil depth 0.5- 1.3m (1.3m deep enough to support large tree planting). Approximate 1,835m2

Total landscape area is approximate 11690m2

Macquarie Park Commerce Centre | Waterloo Rd Macquarie Park

ASPECT Studios











Precedent images

Granite paving and otential spill out space













- nt with bands of decorative ural soil below for stormwater
- sia floribunda 'Sweeper'

Potential 'future' bicycle path shown dotted. To be paved in granite stone to match footpaths, with the potential to be converted to a bicycle path (asphatia as per technical manual) if future demands require

New bus stop (relocated from further west on Waterloo Rd) with new bus shelter

- ement (to ensure continued ing Eucalyptus trees along

Colonnade to building frontage
Granite pavement
Stair transition to corner, with raised seating edges and mass planting
Undercover spill-out space

- s retained in mass planted tree be protected in accordance advice)
- n terrabond tree pits to enable ment through the civic plaza

Raingardens
WSUD infiltration pits mass planted with native
grasses and reeds
Tree planting: Lophostemon confetus

Bicycle parking to Ryde Council's standards

- Eucalyptus saligna s: native grasses and t Schedule: Understory below)

Mass planted tree pits

permeable pavement with seating



Indicative plant schedule

BOTANICAL NAME	COMMON NAME	MATURE HEIGHT	POT SIZE	SPACING
Trees				
Eucalyptus saligna	Sydney Blue Gum	25m	200L	As shown
Lophostemon confertus	Brush Box	16m	200L	As shown
Waterhousia floribunda 'Sweeper'	'Sweeper' Weeping Lillypilly	12m	200L	As shown
Understorey				
Isolepis nodosa	Knobbly Club Rush	1000mm	150mm	300mm
Carex appressa	Tall Sedge	800mm	150mm	300mm
Lomandra longifolia 'Tanika'	'Tanika' Mat Rush	500mm	150mm	400mm
Libertia paniculata	Branching Flag Grass	300mm	150mm	300mm
Lomandra cassica	Mat Rush	400mm	150mm	400mm
Anigozanthes 'Regal Velvet'	Kangaroo Paw	1000mm	150mm	400mm
Pratia pedunculata	Matted Pratia	100mm	50mm	300mm
Scaevola 'Purple Fan Fare'	Fan Flower		150mm	500mm
		300mm		000

Macquarie Park Commerce Centre | Waterloo Rd Macquarie Park

Client:

Concept Design



Civic Frontage: Waterloo Rd + Station interface



Precedent images

Indicative plant

schedule

MMON NAME MATURE HEIGHT

POT SIZE SPACING

g meandering through the

Thru-site link
Mass planting and row of trees to
boundary: Tristania laurina 'Luscious'

Small unit concrete pavers

Rainforest tree and understory species (see plant schedule below)

derstory species. (see plant

Curl Tree on Scented Myrtle wheel Tree

8m 10m 10m 10m

100L 200L 200L 200L 200L









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ASPECT Studios

Concept Design





Architect: Bates Smart

Drawn: Checked

NB SC

ad-leafed Palm Lily
at Rush
ammon Cordyline

one Fern
en Fern
en Fern
s Violet

Scale: Varies @ A1
Date: Sep 14, 2010

Dwg no.: **10030 - LA03**Rev: **E**

Courtyard Links

Public art opportunity>













at the collision of the main routes of travel and desire lines through

Key

- ainforest Stroll Garden
 Rainforest tree and understory species
 Grove tree planting (refer plant schedule)
 Opportunity for moveable and fixed furniture to cater for a
 range of group gatherings and functions
 Mulch surface allowing informal meandering through the
- Timber path and decks

- nwater management zone: planted infiltration bed by stormwater is filtered and piped to a storage tank for
- Mass planted with a range of native grasses, rushes and reeds
- ant existing trees retained along boundary edge mentary native canopy tree planting (refer plant
- nted understory and screen planting (refer plant
- informal turf area
 Potential use for creche/ gym spill-out

- Significant existing trees retained where possible Additional tree planting: Angophora floribunda, to supplement existing and create a double row to the streetscape Mass planted understory of native grasses and groundcovers (refer plant schedule)

Indicative plant schedule

COMMON NAME

POT SIZE

Ivory Curl Tree
Yellow-wood
Hax Leaf Paperbark
Firewheel Tree
Rough-barked Apple
Water Gum

8m 25m 8m 10m 10m

Detail plan

Section C-C

Key plan



Precedent images



















1.5m 500mm 300mm 300mm 1.5m 1.5m 400mm 1m 1m 1m 1m 200mm 500mm 500mm 1000mm 1000mm 1000mm 1000mm





Concept Design



















Dwg no.: **10030 - LA04**Rev: **E**


Garden Courtyard



Macquarie Park Commerce Centre | Waterloo Rd Macquarie Park

Detail plan: Giffnock Ave+ Coolinga St



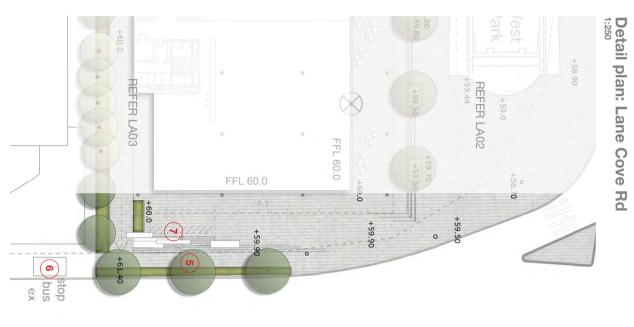

Lane Cove Road

REFER LA03

FFL 56.50

Entry / Exit Entry / Exit Giffnock Avenue

+58.20

+56.50

FFL 56.90

FFL 56.90

FFL 60.0

REFER LA04

FFL 56.90

Macquarie Park Commerce Centre | Waterloo Rd Macquarie Park

ASPECT Studios

































Key

g on street is required g on street is required d Streetscape works pavement ree planting:
The planting:
The confetus in mass

Key plan

- ie proposed to provide ween pedestrians and a of Lane Cove Rd) to tenancies. Bench bands of planting to of stairs, Intended to nee to the geology of distone outcrops and thing
- on adjacent site
- Bicycle parking to Ryde Council's standards

Indicative plant schedule

BOTANICAL NAME	COMMON NAME	MATURE HEIGHT	POT SIZE	SPACING
Trees				
Eucalyptus microcorys	Tallowwood	20m	200L	As shown
Angophora floribunda	Rough-barked Apple	20m	200L	As shown
Lophostemon confertus	Brush Box	15m	200L	As shown
Understorey				
Isolepis nodosa	Knobbly Club Rush	1000mm	150mm	300mm
Carexappressa	Tall Sedge	800mm	150mm	300mm
Lomandra longifolia 'Tanika'	'Tanika' Mat Rush	500mm	150mm	400mm
Libertia paniculata	Branching Flag Grass	300mm	150mm	300mm
Lomandra Cassica	Mat Rush	400mm	150mm	400mm
Anigozanthes 'Regal Velvet'	Kangaroo Paw	1000mm	150mm	400mm
Pratia pedunculata	Matted Pratia	100mm	50mm	300mm
Scaevola 'Purple Fan Fare'	Fan Flower	300mm	150mm	500mm
Hibbertia scandens	Guinea Flower	300mm	150mm	500mm
Scaevola 'Purple Fan Fare'	Fan Flower	300mm	150mm	500mm

Precedent images



















Macquarie Park Commerce Centre

Waterloo Road Macquarie Park

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Shadow Study

Proposed development envelope


Summer Solstice

Legend


Development boundary

Proposed Shadow; Proposed Shadow over Existing Shadow


Existing Buildings

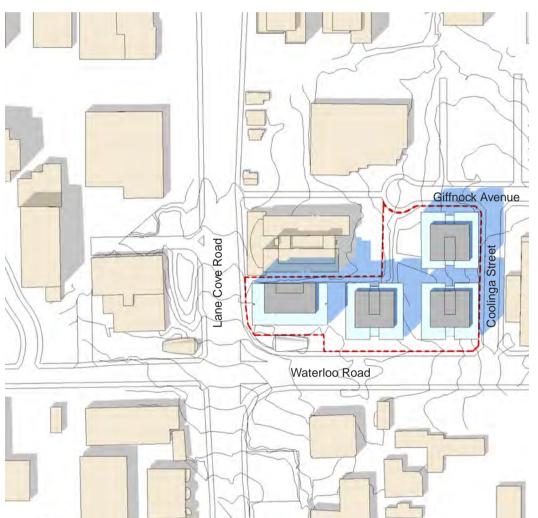



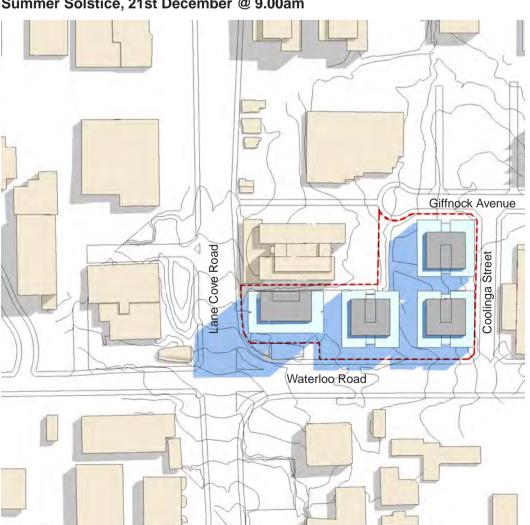

Summer Solstice, 21st December @ 3pm

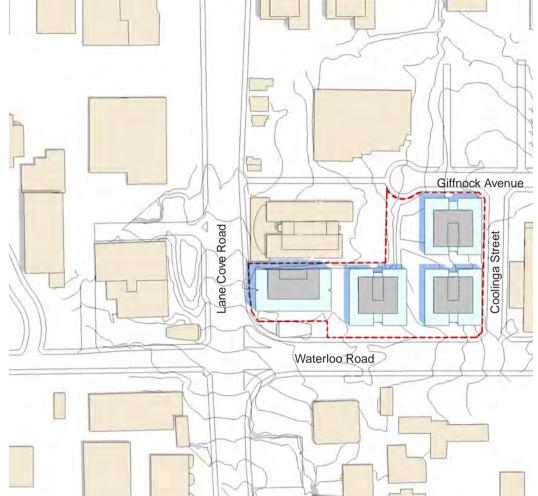

Summer Solstice, 21st December @ 12 noon



Macquarie Park Commerce Centre

Waterloo Road Macquarie Park

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Shadow Study

Proposed development envelope


Autumn Equinox

Legend


Development boundary

Proposed Shadow; Proposed Shadow over Existing Shadow


Existing Buildings

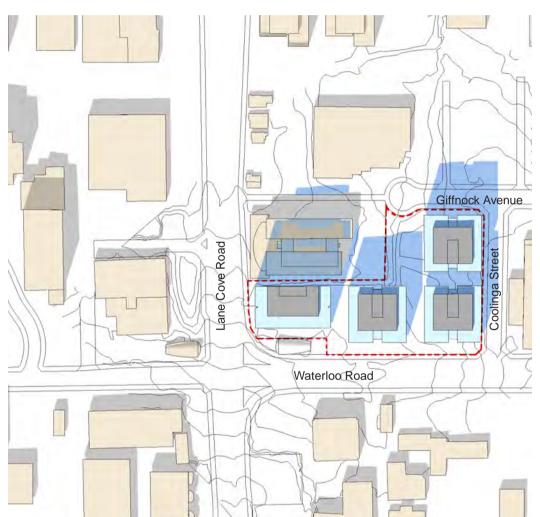



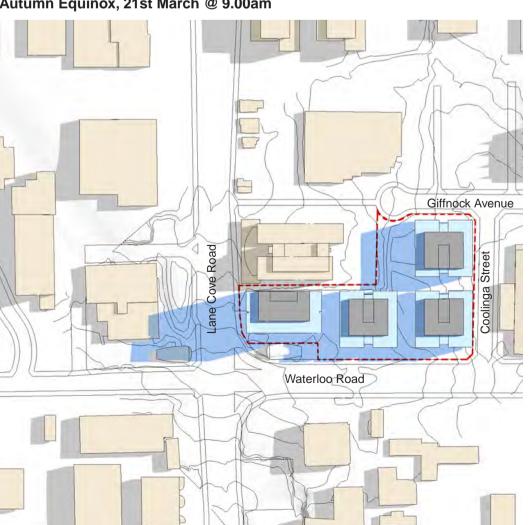



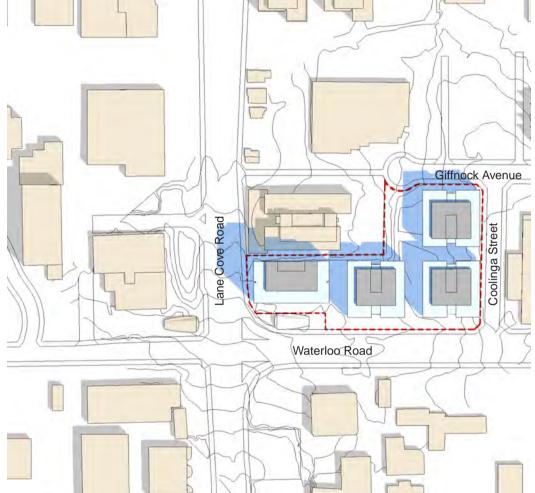

Autumn Equinox, 21st March @ 12 noon



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Waterloo Road Macquarie Park

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Shadow Study

Proposed development envelope

Winter Solstice

N


Legend

Development boundary

Proposed Shadow; Proposed Shadow over Existing Shadow

Existing Buildings



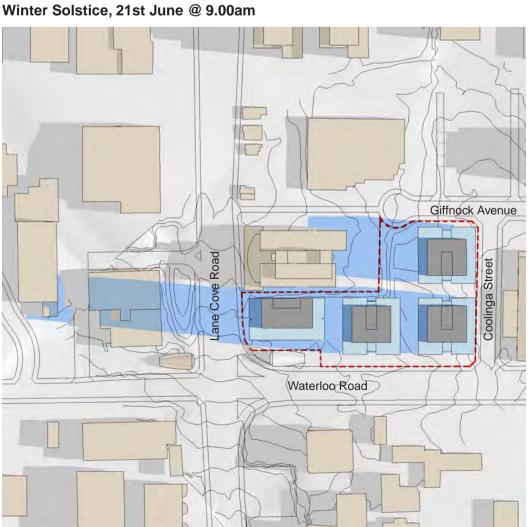

Winter Solstice, 21st June @ 3pm



Winter Solstice, 21st June @ 12 noon



Macquarie Park Commerce Centre

Waterloo Road Macquarie Park

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Shadow Study

Proposed development envelope

Spring Equinox


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Legend


Development boundary

Proposed Shadow; Proposed Shadow over Existing Shadow


Existing Buildings



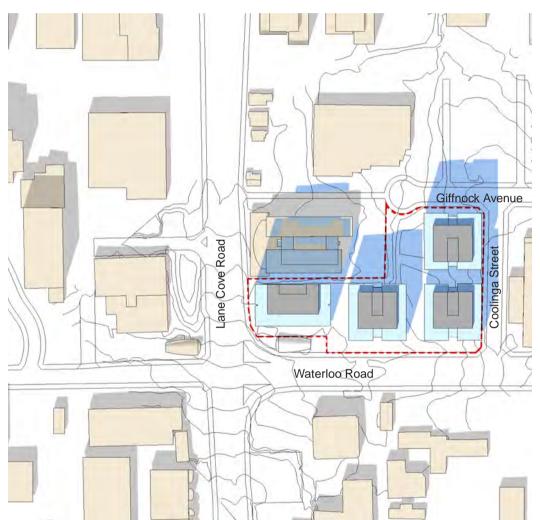

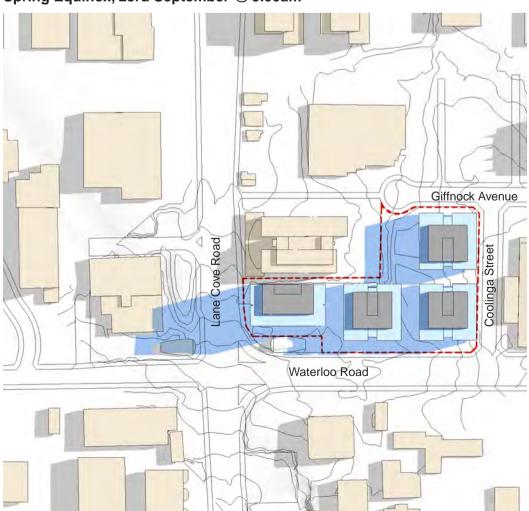

Spring Equinox, 23rd September @ 3pm

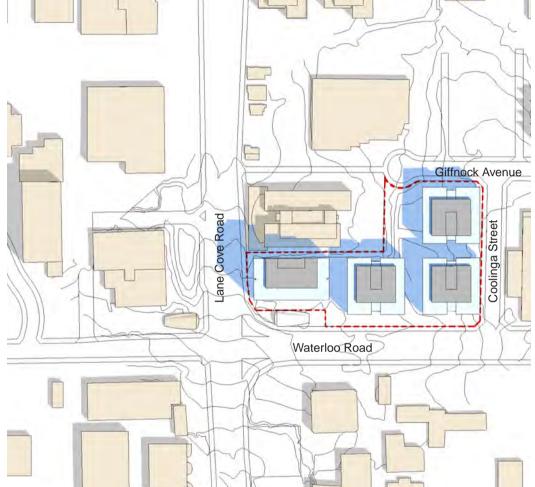

Spring Equinox, 23rd September @ 12 noon



Macquarie Park Commerce Centre

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